BEACH CITIES HEALTH DISTRICT HEALTHY LIVING CAMPUS

514 NORTH PROSPECT AVENUE, REDONDO BEACH, CA 90277 OWNER CONTACT: BEACH CITIES HEALTH DISTRICT | TOM BAKALY | TEL: 310.374.3426, x118 | WWW.BCHD.ORG



PAUL MURDOCH ARCHITECTS

6310 SAN VICENTE BLVD SUITE 400 LOS ANGELES, CALIFORNIA 90048 310 358-0993

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WITH FABRICATION

514 NORTH PROSPECT AVE. REDONDO BEACH, CA 90277

PMA PROJECT NO.

DRAWING TITLE **COVER SHEET**

02/02/2022

ARTIST'S RENDITION

BEACH CITIES HEALTH DISTRICT HEALTHY LIVING CAMPUS

514 NORTH PROSPECT AVENUE, REDONDO BEACH, CA 90277



GALVANIZED IRON

GLASS

GRADE

GRANITE

GRATING

H HANDICAP

HANGER

HARDBOARD

HARDNER

HARDWARE

HARDWOOD

HEXAGONAL

HIGH POINT

HOLLOW CORE

HORIZONTAL

HOSE BIBB

HOUR

I BEAM

INCH

J JOINT

L LABORATORY

LAMINATE

LAVATORY

LINOLEUM

LUMBER

MATERIAL

MAXIMUM

METAL

MECHANICAL

MISCELLANEOUS

NATURAL GRADE

NOT IN CONTRACT

NOMINAL

NORTH

MOULDING

MOUNTED

LANDING

LEVEL

LIGHT

INFORMATION

INSULATION

INTERIOR

INSIDE DIAMETER

INTERIOR GRADE

INTERMEDIATE

HOLLOW METAL

HORIZONTAL HOOK

HEADER

HEIGHT

GYPSUM BOARD

GOVERNMENT

GRAB BAR

CORR.

CSK.

CFM

CU. FT.

CU. IN.

CU. YD.

DEG. or '

DEPT.

DET.

DIA. or

DIM.

DISP.

DIST.

ELEC.

ELEV.

EMER.

E.V.C.

EQUIP.

EXC.

EXIST.

ENGR., EN

DRAWING INDEX

G000	COVER SHEET
G001	TITLE SHEET
REFERENCE	
R001	SITE SURVEY
R002	EXISTING TREE PLAN
R003	EXISTING TREE DEMO PLAN

LANDSCAPE

TITLE SHEET

GRADING PLAN

LOW IMPACT

UTILITY PLAN

ELEVATIONS

FIRE ACCESS PLAN

EROSION CONTROL PLAN

DEVELOPMENT/DRAINAGE PLAN

NEW 4160VA MEDIUM VOLTAGE SERVICE FROM SCE SINGLE LINE

METAL CLAD 5KV SWITCHGEAR

ELECTRICAL YARD FOR BEACH

CITIES FACILITY AT 15KV

CIVIL

PAUL MURDOCH ARCHITECTS

PAMELA BURTON & COMPANY

LOS ANGELES, CA 90048

TEL: (310) 358-0993

1430 OLYMPIC BLVD.

TEL: (310) 828-6373

319 MAIN STREET

TEL: (213) 239-9700

SANTA MONICA, CA 90404

LABIB FUNK + ASSOCIATES

EL SEGUNDO, CA 90245

LUCCI + ASSOCIATES, INC.

3251 CORTE MALPASO #511

EMAIL: KEN@LUCCILAND.COM

CAMARILLO, CA 93012

TEL: (805) 389-6519

6310 SAN VICENTE BLVD SUITE 400

EMAIL: PAUL@PAULMURDOCHARCHITECTS.COM

EMAIL: DCOLBECK@PAMELABURTONCO.COM

EMAIL: KYLE.PROUTY@LABIBFUNK.COM

EXISTING SITE PLAN EXISTING OPEN SPACE SITE PLAN EXISTING + PROPOSED SITE PLAN OPEN SPACE SITE PLAN FLOOR PLANS

FLOOR PLANS COMPARATIVE SECTIONS SITE SECTIONS SITE SECTIONS **EXISTING NORTHEAST 3D MASSING** NORTHEAST 3D MASSING VIEW

NORTHWEST 3D MASSING VIEW SOUTHEAST 3D MASSING VIEW SOUTHWEST 3D MASSING VIEW **ELEVATIONS ELEVATIONS** NORTHEAST PERPECTIVE VIEW

CONSULTANT TEAM

LANDSCAPE ARCHITECT:

ELECTRICAL ENGINEER:

CIVIL ENGINEER:

SYMBOLS

ARCHITECT:

SOUTHEAST PERPECTIVE VIEW MATERIALS + COLOR PALETTE

PROJECT SCOPE

THE PROPOSED BEACH CITIES HEALTH DISTRICT (BCHD) HEALTHY LIVING CAMPUS MASTER PLAN (PROJECT) WOULD REDEVELOP THE EXISTING BCHD CAMPUS LOCATED IN THE CITY OF REDONDO BEACH. THE PROPOSED PROJECT INCLUDES THE SITE DEVELOPEMNENT OF ASSISTED LIVING, MEMORY CARE, COMUNITY SERVICES MEDICAL SERVICE SPACE. A YOUTH CENTER, SURFACE PARKING, AND PROGRAMMABLE OPEN SPACE, THE PROJECT WILL BE CARRIED OUT IN THREE (3) PHASES:

PHASE 1A: RELOCATION OF EXISTING COOLING TOWERS AND GRADING AT NORTH OF SITE.

PHASE 1B: CONSTRUCTION OF THE PROPOSED BUILDING.

PHASE 1C: DEMOLITION OF THE EXISTING 514 BUILDING. CONSTRUCTION OF PARKING AND PROGRAMMABLI

LEGAL DESCRIPTION

BEACH CITIES HEALTH DISTRICT PROJECT ADDRESS: 514 NORTH PROSPECT AVENUE REDONDO BEACH, CA 90277

ZONING INFORMATION

LAND USE DESIGNATIONS AND ZONING REFERENCES:

CITY OF REDONDO BEACH GENERAL PLAN (CITY OF REDONDO BEACH 2008, 2011, SECTION 3.10 LAND USE AND PLANNING).

750-2017-902 **ZONING DISTRICT** C-2 COMMERCIAL ZONE C-2, COMMERCIAL 0.43 ACRES

11'-0" FRONT SET BACK FRONT UTILITY SET BACK 11'-0" 11'-0"

HEIGHTS

7502-017-903 P-CF COMMUNITY FACILITY ZONE P PUBLIC OR INSTITUTIONAL

SETBACKS SETBACKS SHALL BE DETERMINED SUBJECT TO PLANNING COMMISSION DESIGN REVIEW.

HEIGHTS MAX. HEIGHT

*HEIGHT OF BUILDINGS OR STRUCTURES SHALL BE DETERMINED


BUILDING CONSTRUCTION TYPE I-A UNSEPARATED OR 2A WITH VERTICAL SEPARATION

MEMORY CARE: A-3 (ACCESSORY TO ASSISTED **COMMUNITY SERVICES:** PACE MEDICAL SERVICE:

SERVICE/ PARKING:

BUILDING HEIGHT: 108'-8"

GROSS FLOOR AREA: 292,170 SF

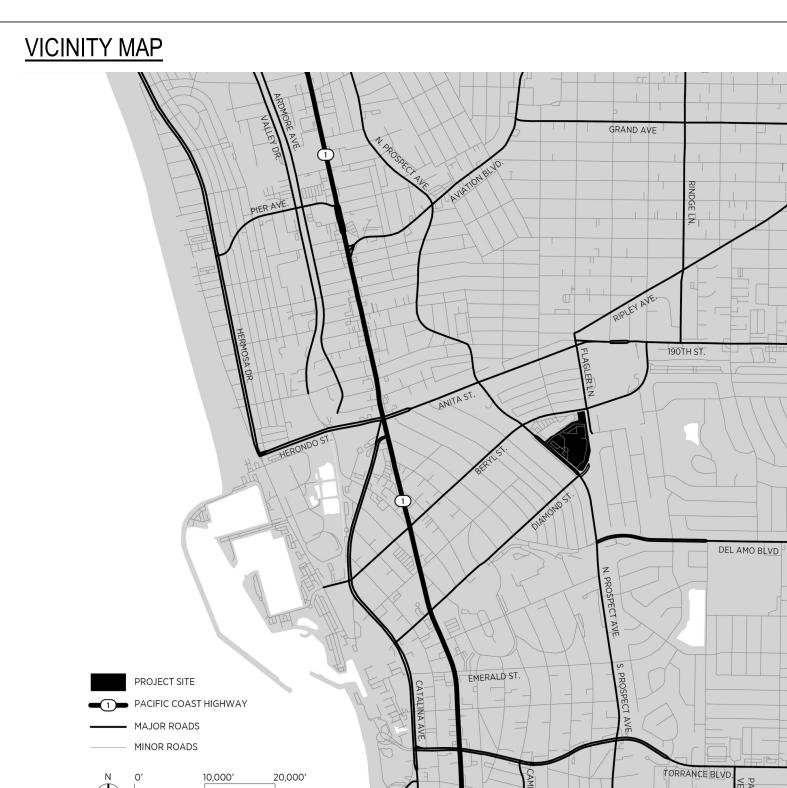

7502-017-903

REDONDO BEACH ZONING ORDINANCE

REDONDO BEACH MUNICIPAL CODE TITLE 10 PLANNING AND ZONING CHAPTER 2 ZONING AND LAND

MAX. HEIGHT

30'-0" FROM CENTER

LINE OF (E) GRADE

<u>PROPOSED</u>

30'-0"

ZONING DISTRICT LAND USE: AREA: **9.94 ACRES**

PROPOSED 107'-6"

SUBJECT TO PLANNING COMMISSION DESIGN REVIEW.


BUILDING DATA

BUILDING OCCUPANCY:

ASSISTED LIVING: R-2.1

LIVING AND MEMORY CARE) A-3 (ACCESSORY TO ASSISTED YOUTH WELLNESS CENTER: LIVING AND MEMORY CARE)

NO. OF STORIES: 6.5 STORIES ABOVE AND 2 BASEMENT STORIES

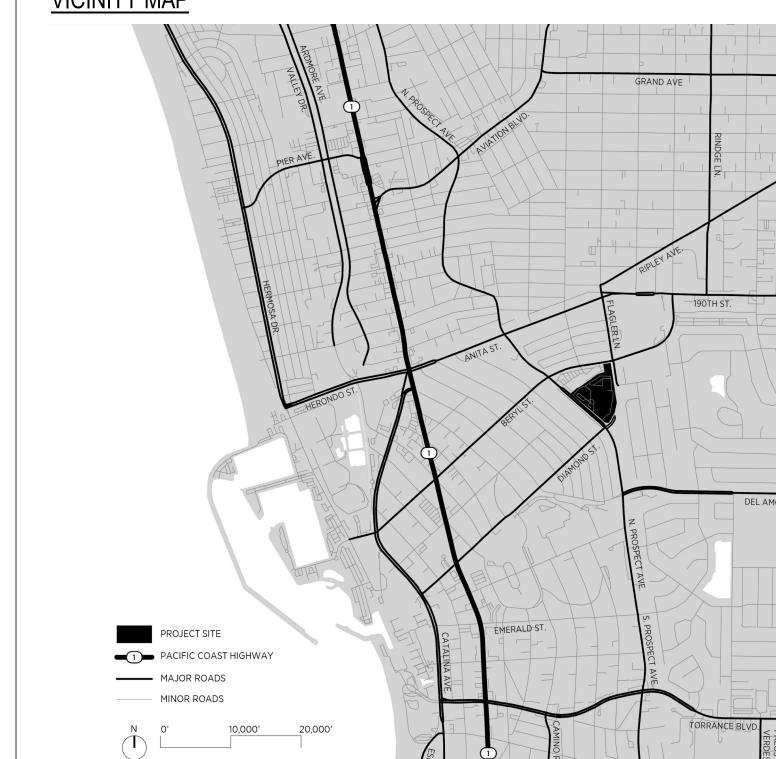

ASSOCIATION

AUTOMATIC

AVENUE

B BASEMENT

BEAM

BETWEEN

BLOCKING

BOTH WAYS

BOULEVARD

BRACKET

BRONZE BUILDING

C CABINET

CARPET

CAST IRON

CEILING

CEMENT

CENTER

CENTERLINE

CERAMIC TILE

CERAMIC TILE

CHALKBOARD

CHANGE

CLEAN OUT

CLEAR

COLUMN

COMMON

COMPANY

CONCRETE

COMMUNICATION

COMPOSITION

CONNECTION

CONTROL JOINT

CONCRETE BLOCK

CONCRETE MASONRY UNIT

CONTINUOUS or CONTINUE

CONTRACT or CONTRACTOR

CONSTRUCT or CONSTRUCTION

CAST IRON PIPE

CATCH BASIN

CENTER TO CENTER

BOTTOM OF JOINT

BRITISH THERMAL UNITS

BOTTOM

BLOCK

BOARD

ABBREVIATIONS ABOVE FINISH FLOOR ACCESS PANEL ACOUSTICAL CEILING TILE AGGREGATE AIR CONDITION ALUMINUM AMERICAN CONCRETE INSTITUTE AMERICAN INSTITUTE OF STEEL CONSTRUCTION AISC or A.I.S.C. AMERICAN NATIONAL STANDARDS INSTITUTE AMERICAN SOCIETY OF CIVIL ENGINEERS AMERICAN SOCIETY OF TESTING AND MATERIAL ASTM AMERICAN WELDING SOCIETY **AMOUNT** ANCHOR BOLT ANODIZED **APPROVED APPROX APPROXIMATE** ARCHITECT OR ARCHITECTURAL **ASBESTOS** ASPHALT ASPHALT TILE ASPHALTIC CONCRETE ASSOCIATE ASSOC.

ASSN. BOARD OF AIRPORT COMMISSIONERS **BOTTOM OF MULLION**

BLDG.

CTR. COM. CONC.

CONT.

CONTR.

EXTERIOR GRADE EXTRUDED EYE WASH F FABRIC WALL COVERING FABRIC WALL PANEL FACE OF CONCRETE FACE OF MASONRY FACE OF STUD **FACTORY** FEET / FOOT FIGURE FINISH FINISH FACE FIRE ALARM PULL FIRE EXTINGUISHER FIRE HOSE CABINET FIRE HYDRANT FIREMAN'S PHONE JACK FLANGE FLATHEAD WOOD SCREWS FLOOR FLOOR DRAIN FLOOR SINK FLOW LINE FLUOROCARBON RESINOUS COATED

FOOTING

G GAGE

GALLON

FOUNDATION

GALVANIZED

CORRIDOR

CUBIC INCH

CUBIC YARD

CURB FACE

DEPARTMENT

DETAIL

DIAGONAL

DIAMETER

DIMENSION

DISPENSER

DISTANCE

DIVISION

DOOR

DOUBLE

DOWEL

DOWN

DOWNSPOUT

DRINKING FOUNTAIN

ELASTOMERIC MEMBRANE

ELECTRIC or ELECTRICAL

END VERTICAL CURVE

DRAWING

ELEVATION

ELEVATOR

ENAMEL

ENGINEER

EQUIPMENT

ESTIMATE

EXCAVATE

EXISTING

EXISTING'

EXTERIOR

EXPANSION BOLT

EXPANSION JOINT

EXPOSED CONSTRUCTION

EQUAL

EMERGENCY

E EACH

CUBIC

COUNTERSINK

CUBIC FEET PER MINUTE

EXT. GR. EXTR. E.W. F.W.C. F.W.P. M MACHINE F.O. F.O.C. F.O.M. F.O.S. FLG. F.H.W.S. F.S. N NATIONAL F.L. or **FCRC** FTG.

MANUFACTURER or MANUFACTURING MANUFACTURERS ASSOC. MASONRY OPENING MEDICINE CABINET MEMBRANE WATERPROOFING MINERAL FISSURED TILE NATIONAL BOARD OF FIRE UNDERWRITERS NATIONAL ELECTRICAL CODE

OUTSIDE DIAMETER **OUTSIDE FACE CONCRETE OUTSIDE FACE MASONRY** O.F.M. OUTSIDE FACE STUDS OVER FLOW DRAIN P PAINTED **PANEL** PARTITION **PEDESTAL** PENNY PERFORATED PERPENDICULAR PICKET FENCE PIECE PIPE BOLLARD PLASTER PLASTIC LAMINATE PLATE PLYWOOD POLYURETHANE ENAMEL POLYVINYL CHLORIDE PORTLAND CEMENT CONCRETE POUND LB. or # **POWER POLE** PRCST. PRECAST **PREFABRICATED** PREFAB. **PROPERTY** PROP. PROPERTY LINE PULL CHAIN Q QUARRY TILE R RADIUS RECTANGLE REDWOOD REFER TO REFLECTED CEILING PLAN REFRIGERATOR REINFORCE or REINFORCING REQUIRED REVISION RIGHT-OF-WAY RISER ROOF **ROOF DRAIN ROOFING** ROOM ROUGH OPENING ROUND RUBBER BASE SECTION SHEATHING SHEET SIMILAR SMOKE DETECTOR SNITARY SEWER SOLID CORE SOUTH SPEAKER SPECIFICATION

STAGGERED

STANDARD

STEEL

STAINLESS STEEL

NOT TO SCALE

O OCCUPATIONAL SAFETY AND HEALTH ADMINIST O.S.H.A.

NUMBER

ON CENTER

OPPOSITE

OUT TO OUT

OPENING

GRAN.

GRTG.

N.T.S.

O TO 0

STRAIGHT GRADE STREET STRUCTURAL SUPPORT SURFACED 4 SIDES SUSPEND SYMBOL SYMMETRICAL T TELEPHONE **TEMPERATURE** TERAZZO THICK or THICKNESS THRESHOLD TO OF **TONGUE AND GROOVE** TOP OF BANK TOP OF CURB TOP OF DECK TOP OF FINISH TOP OF GRATE TOP OF JOINT TOP OF MASONRY TOP OF PARAPET TOP OF STEEL TOP OF STRUCTURAL SLAB TOP OF WALL TREAD TURNBUCKLE TYPICAL U UNDER CUT UNIFORM BUILDING CODE **UNLESS NOTED OTHERWISE** V VEE JOINT VENTILATOR VERIFY IN FIELD VERTICAL VESTIBULE VINYL COMPOSITION TILE VINYL WALL COVERING VOLUME W WAREHOUSE WATER CLOSET WATER HEATER WATER RESISTANT WATERPROOF or WATERPROOFING WELDED WIRE FABRIC WIDE FLANGE (STEEL)

WOOD

Y YARD

STIFFENER

STIRRUP

STONE

T.O.P. TOS / T.O.S. T.S.S. T.O.W. TRNBKL. U.B.C. U.N.O. V JT.

STIFF.

STIR.

STN.

STRUCT'L

SUPT.

SUSP.

SYM.

SYMM.

TEMP.

TERR.

T.O.B.

T.O.C.

T.M.D.

T.O.F.

T.O.J.

T.O.M.

VENT. VERT. VEST. VYN VCT VWC VOL. WHSE

EXISTING COLUMN GRID LINE CENTERLINE PROPERTY LINE **OBJECTS BEHIND OBJECTS ABOVE** ROOM # **ROOM TAG ELEVATION REFERENCE**

DETAIL REFERENCE

POINT ELEVATION / LEVEL TARGET WINDOW TYPE

DOOR NUMBER

INTERIOR ELEVATION REFERENCE

REVISION NUMBER

WALL ASSEMBLY TYPE

NEW COLUMN GRID

PAUL MURDOCH

ARCHITECTS

6310 SAN VICENTE BLVD SUITE 400

LOS ANGELES, CALIFORNIA 90048

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DATE BEACH CITIES

514 NORTH PROSPECT AVE REDONDO BEACH, CA 90277

HEALTH DISTRICT

HEALTHY LIVING

CAMPUS

MA PROJECT NO.

RAWING TITLE TITLE SHEET


02/02/2022

SHEET NO.

G001

CHECKED

PM

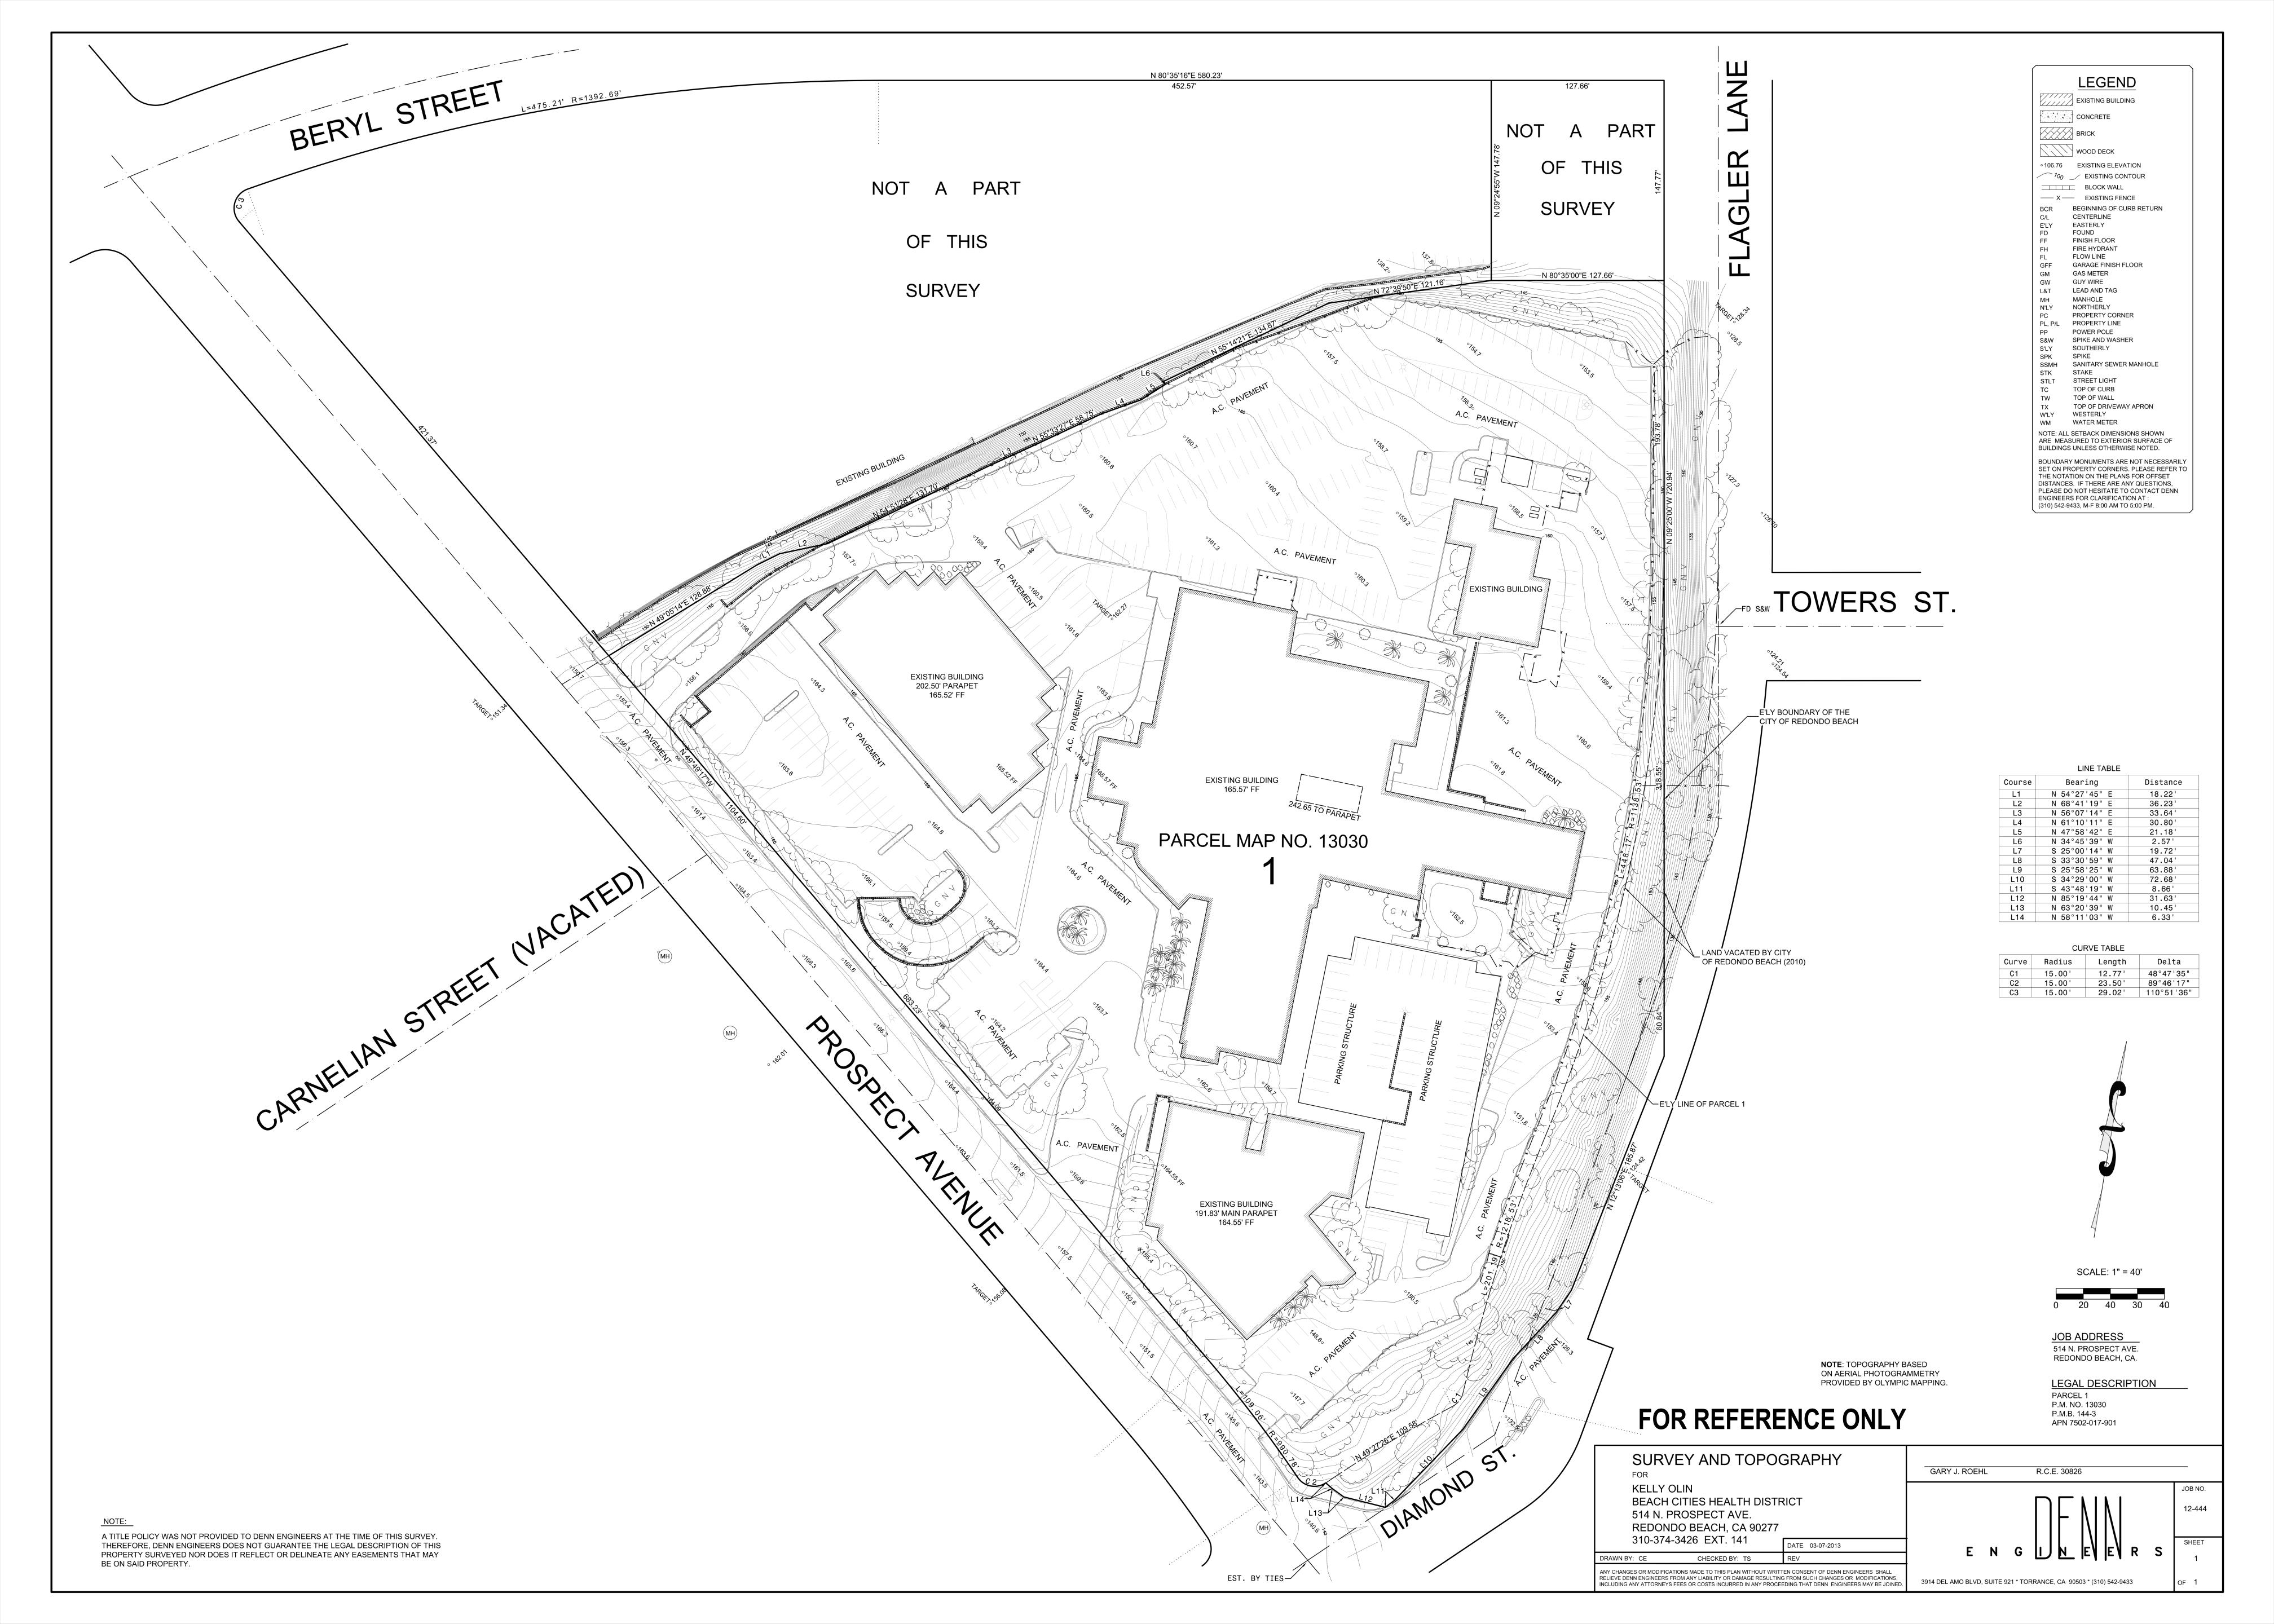







EXISTING LAND USE DESIGNATIONS AND ZONING

ZONING DISTRICT P-CF COMMUNITY FACILITY ZONE

7502-017-903

LAND USE: P PUBLIC OR INSTITUTIONAL

9.94 ACRES

750-2017-902

ZONING DISTRICT C-2 COMMERCIAL ZONE

LAND USE: C-2, COMMERCIAL

0.43 ACRES

LAND USE DESIGNATIONS AND ZONING REFERENCES:

- CITY OF REDONDO BEACH GENERAL PLAN (CITY OF REDONDO BEACH 2008, 2011, SECTION 3.10 LAND USE AND PLANNING),
- REDONDO BEACH ZONING ORDINANCE
- REDONDO BEACH MUNICIPAL CODE TITLE 10 PLANNING AND ZONING CHAPTER 2 ZONING AND LAND USE

EXISTING SITE OPEN SPACE

50,950 SF OTHER 31,910 SF **TOTAL EXISTING OPEN SPACE** 82,940 SF

EXISTING PARKING

41 SPACES 3 ACCESSIBLE PK:E1 257 SPACES 3 ACCESSIBLE PK:E2 24 SPACES 4 ACCESSIBLE PK:E3 281 SPACES 8 ACCESSIBLE PK:E4* 199 SPACES 2 ACCESSIBLE **PK:E5*** 11 SPACES 0 ACCESSIBLE **PK:E6*** TOTAL* 813 TOTAL 20 ACCESSIBLE *TOTAL PK:E4 281 SPACES 8 ACCESSIBLE 4 ACCESSIBLE SURFACE 62 SPACES 4 ACCESSIBLE 107 SPACES 0 ACCESSIBLE *TOTAL PK:E5 199 SPACES 2 ACCESSIBLE

0 ACCESSIBLE TOP DECK 59 SPACES 2ND LEVEL 52 SPACES 0 ACCESSIBLE 1ST LEVEL UNDERGROUND 53 SPACES 2 ACCESSIBLE 0 ACCESSIBLE 35 SPACES

395 SPACES

*TOTAL (E) STRUCTURE 418 SPACES 6 ACCESSIBLE *PARKING SPACES SUBTOTALS + TOTALS INCLUDE ACESSIBLE SPACES.

14 ACCESSIBLE

SYMBOL LEGEND

PEDESTRIAN ENTRY / EXIT

VEHICULAR ENTRY / EXIT

PAUL MURDOCH ARCHITECTS

6310 SAN VICENTE BLVD SUITE 400 LOS ANGELES, CALIFORNIA 90048

310 358-0993

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NO. DATE BEACH CITIES **HEALTH DISTRICT HEALTHY LIVING** CAMPUS

514 NORTH PROSPECT AVE. REDONDO BEACH, CA 90277

PMA PROJECT NO.


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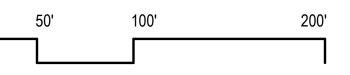
EXISTING SITE PLAN


AS INDICATED

DATE 02/02/2022 PM

(E) A100



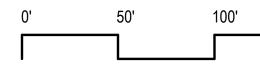

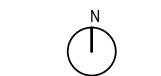



EXISTING SITE OPEN SPACE

SOFTSCAPE 83,900 SF UNDEVELOPED LAND 18,900 SF HARDSCAPE 228,900 SF BUILDINGS 120,400 SF **TOTAL SITE AREA** 452,100 SF

*PROGRAMMABLE OPEN SPACE 0.03 ACRES

331,700 SF

SYMBOL LEGEND

SOFTSCAPE 18% OF TOTAL SITE AREA

4% OF TOTAL SITE AREA

0.3% OF TOTAL SITE AREA UNDEVELOPED LAND

PROGRAMMABLE OPEN SPACE



HARDSCAPE 51% OF TOTAL SITE AREA



BUILDINGS 27% OF TOTAL SITE AREA

HARDSCAPE + BUILDING EQUALS 78% OF TOTAL SITE AREA

NO. DATE

BEACH CITIES HEALTH DISTRICT HEALTHY LIVING CAMPUS

PAUL MURDOCH ARCHITECTS

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EXISTING OPEN SPACE SITE PLAN


AS INDICATED

DATE 02/02/2022 CHECKED PM

(E) A101



EXISTING SITE PLAN

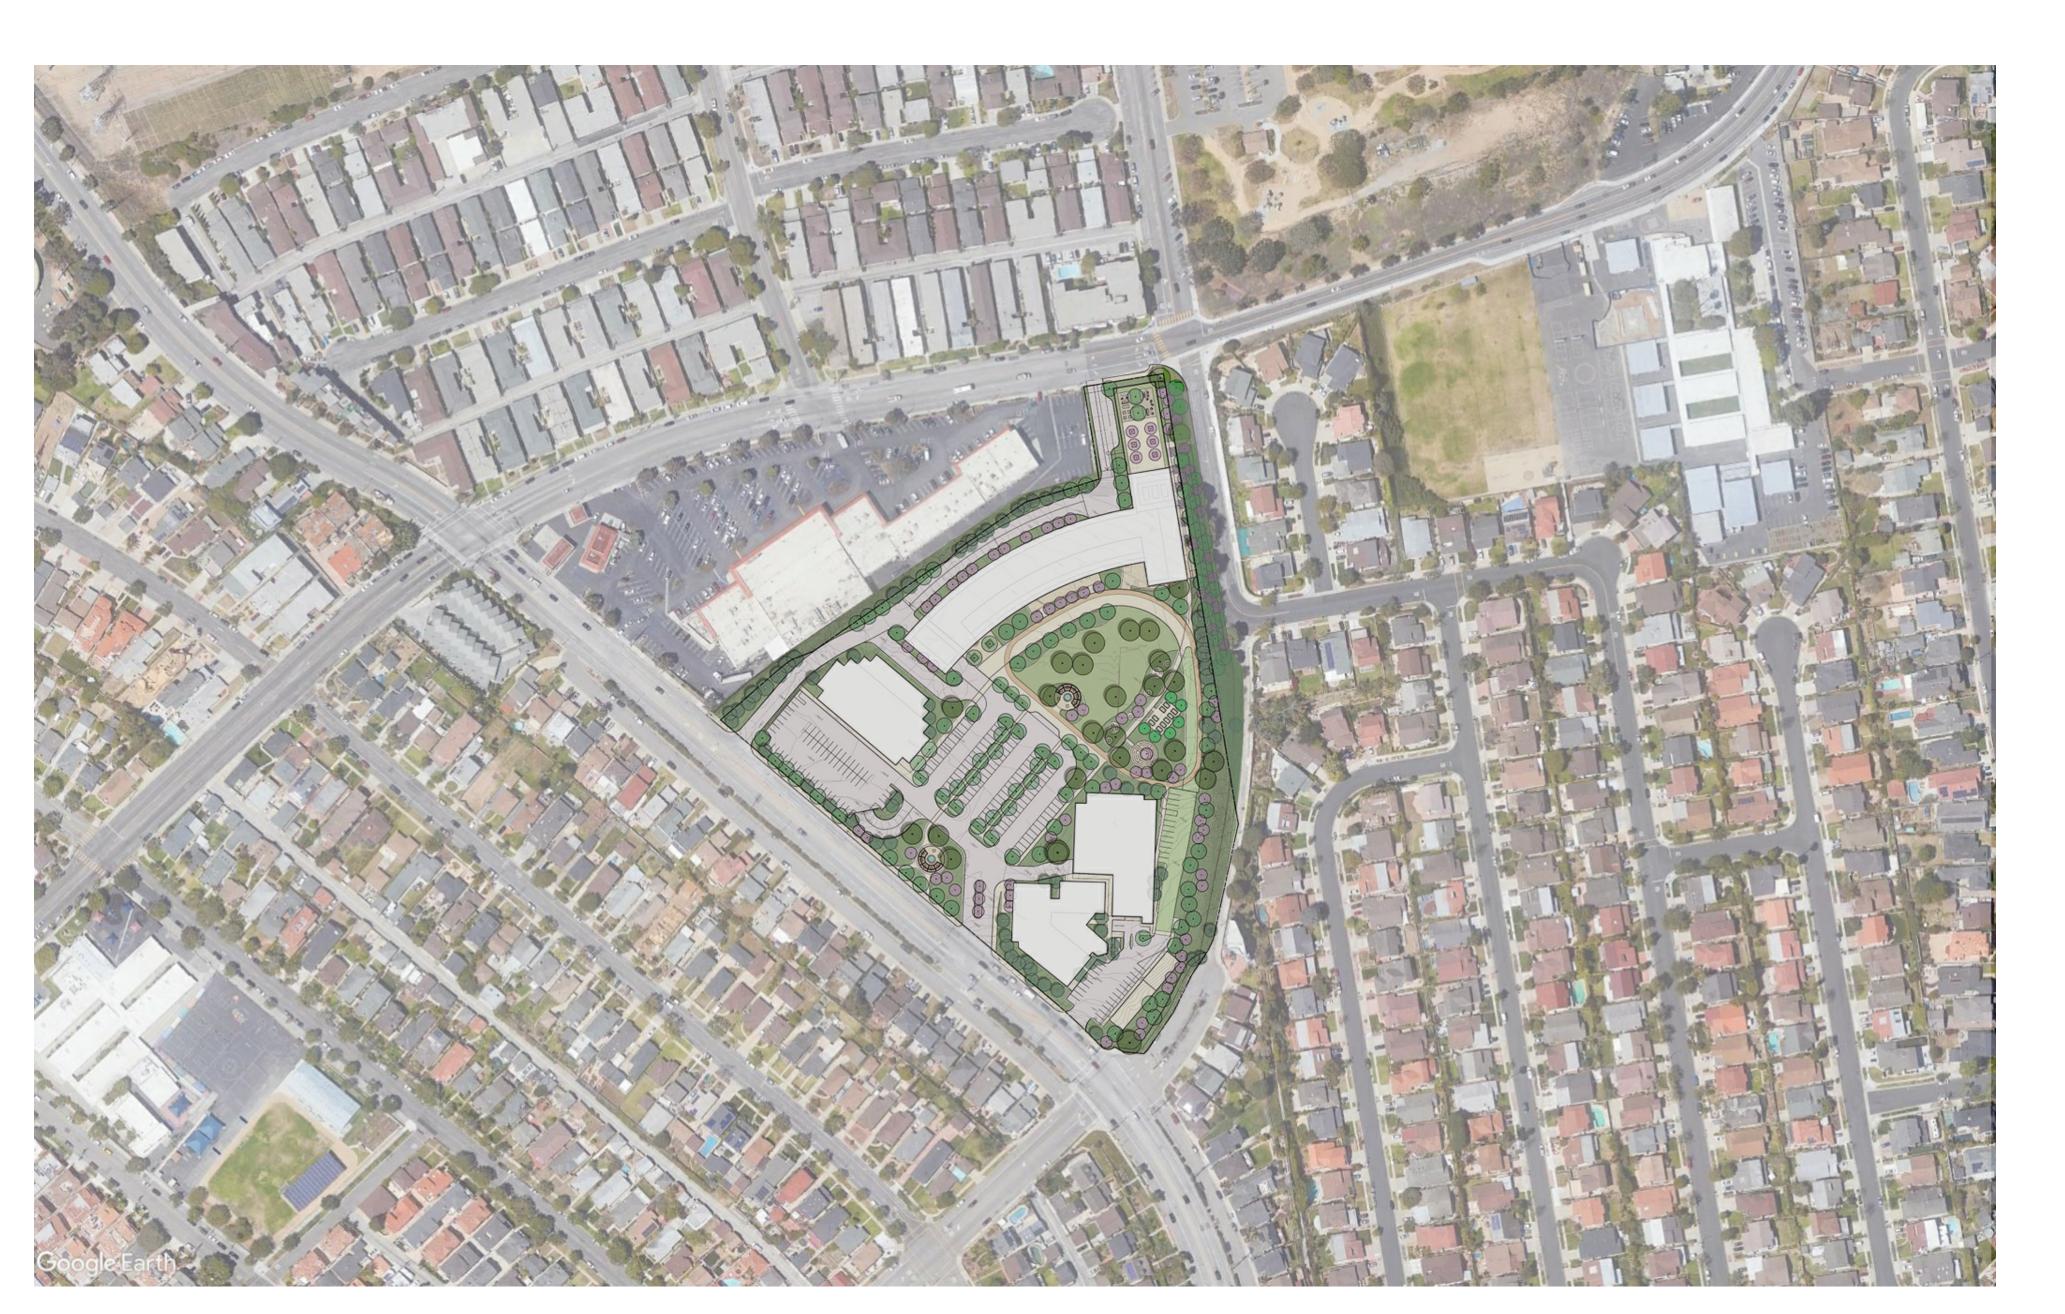

PROPOSED SITE PLAN

PAUL MURDOCH ARCHITECTS

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CAMPUS


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PMA PROJECT NO.

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EXISTING + PROPOSED SITE PLAN

DATE 02/02/2022



SITE OPEN SPACE

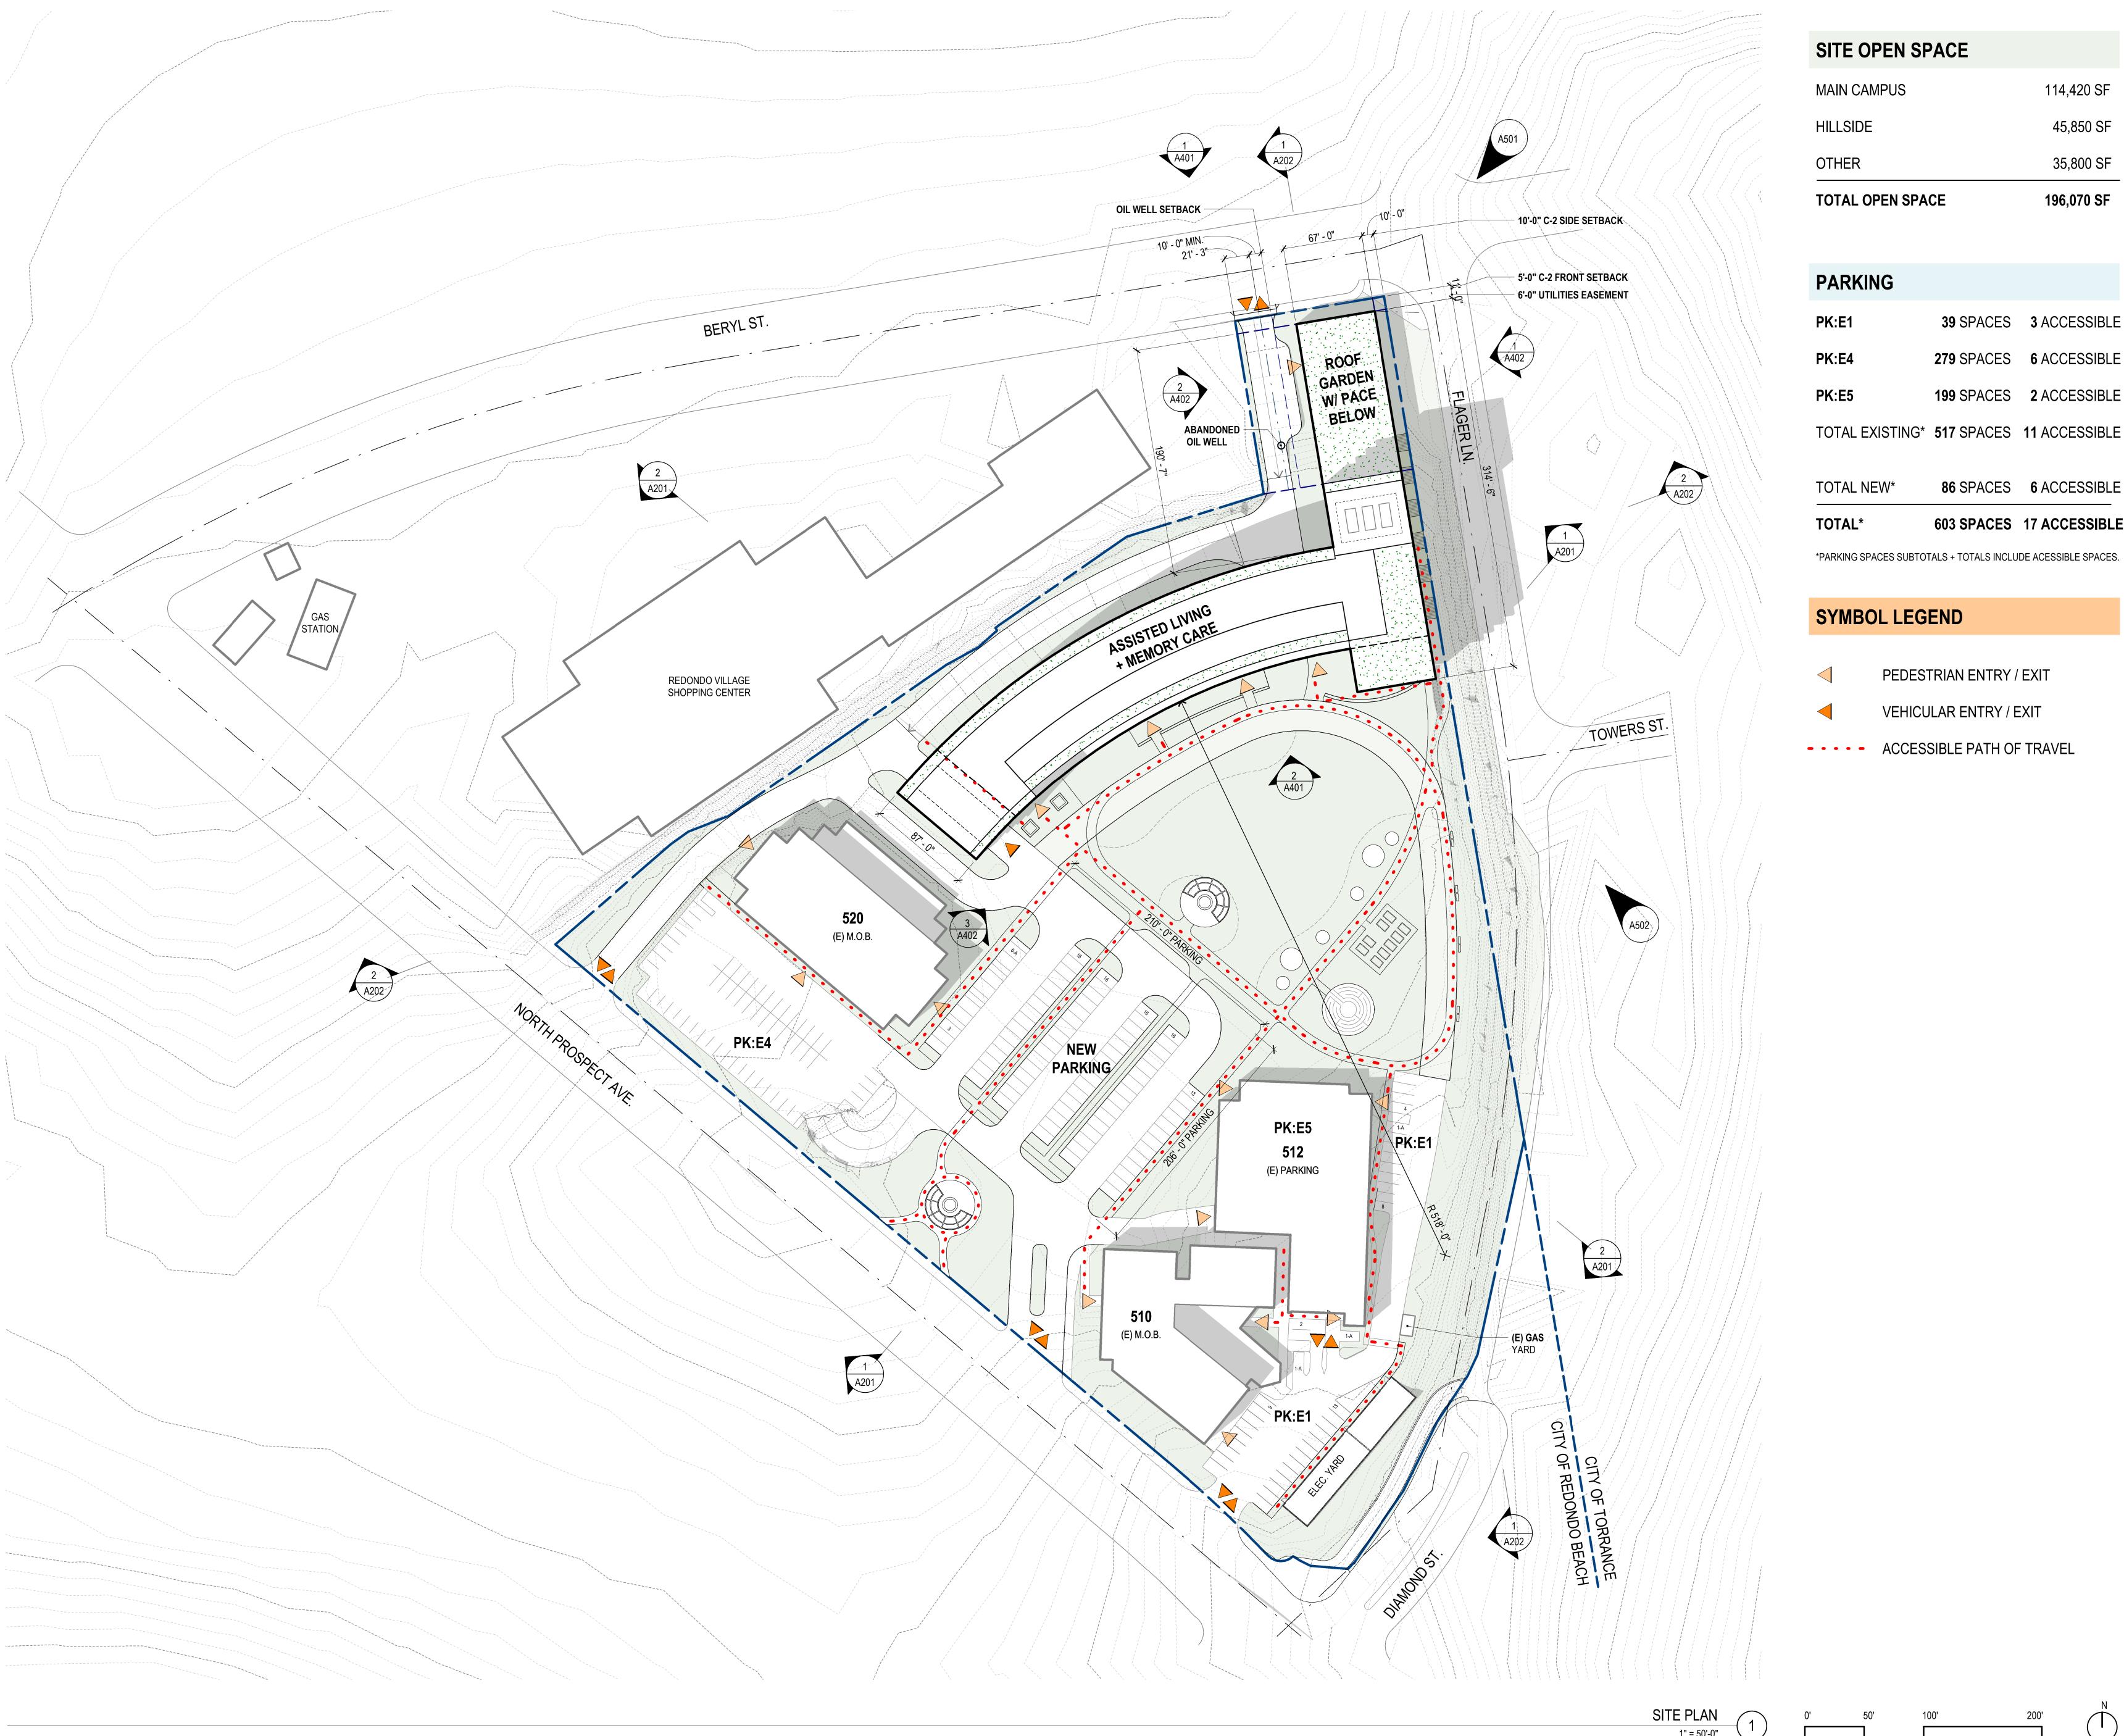MAIN CAMPUS 114,420 SF HILLSIDE 45,850 SF OTHER 35,800 SF

TOTAL OPEN SPACE 196,070 SF

PARKING

PK:E1 **39** SPACES **3** ACCESSIBLE PK:E4 **279** SPACES **6** ACCESSIBLE PK:E5 **199** SPACES **2** ACCESSIBLE

86 SPACES 6 ACCESSIBLE **TOTAL NEW***

*PARKING SPACES SUBTOTALS + TOTALS INCLUDE ACESSIBLE SPACES.

603 SPACES 17 ACCESSIBLE

SYMBOL LEGEND

PEDESTRIAN ENTRY / EXIT

VEHICULAR ENTRY / EXIT

- - - - ACCESSIBLE PATH OF TRAVEL

NO. DATE BEACH CITIES HEALTH DISTRICT HEALTHY LIVING CAMPUS

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DRAWING TITLE

SITE PLAN

AS INDICATED DATE 02/02/2022

A101

PM



203,500 SF 139,000 SF 452,100 SF

342,500 SF

*PROGRAMMABLE OPEN SPACE 2.12 ACRES

25% OF TOTAL SITE AREA

PROGRAMMABLE OPEN SPACE 20% OF TOTAL SITE AREA

31% OF TOTAL SITE AREA

24% OF TOTAL SITE AREA

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DIMENSIONS. CONTRACTORS CHALL VERSES AND RE-DRAWINGS SHALL HAVE PRECEDENCE OVER SCALED DIMENSIONS. CONTRACTORS SHALL VERIFY AND BE RESPONSIBLE FOR ALL DIMENSIONS AND CONDITIONS ON THE JOB AND THIS OFFICE MUST BE NOTIFIED OF ANY VARIATIONS FROM THE DIMENSIONS AND CONDITIONS SHOWN BY THESE DRAWINGS. SHOP DETAILS MUST BE SUBMITTED TO THIS OFFICE FOR REVIEW BEFORE PROCEEDING WITH FABRICATION

NO. DATE BEACH CITIES HEALTH DISTRICT HEALTHY LIVING

514 NORTH PROSPECT AVE. REDONDO BEACH, CA 90277

CAMPUS

PMA PROJECT NO.


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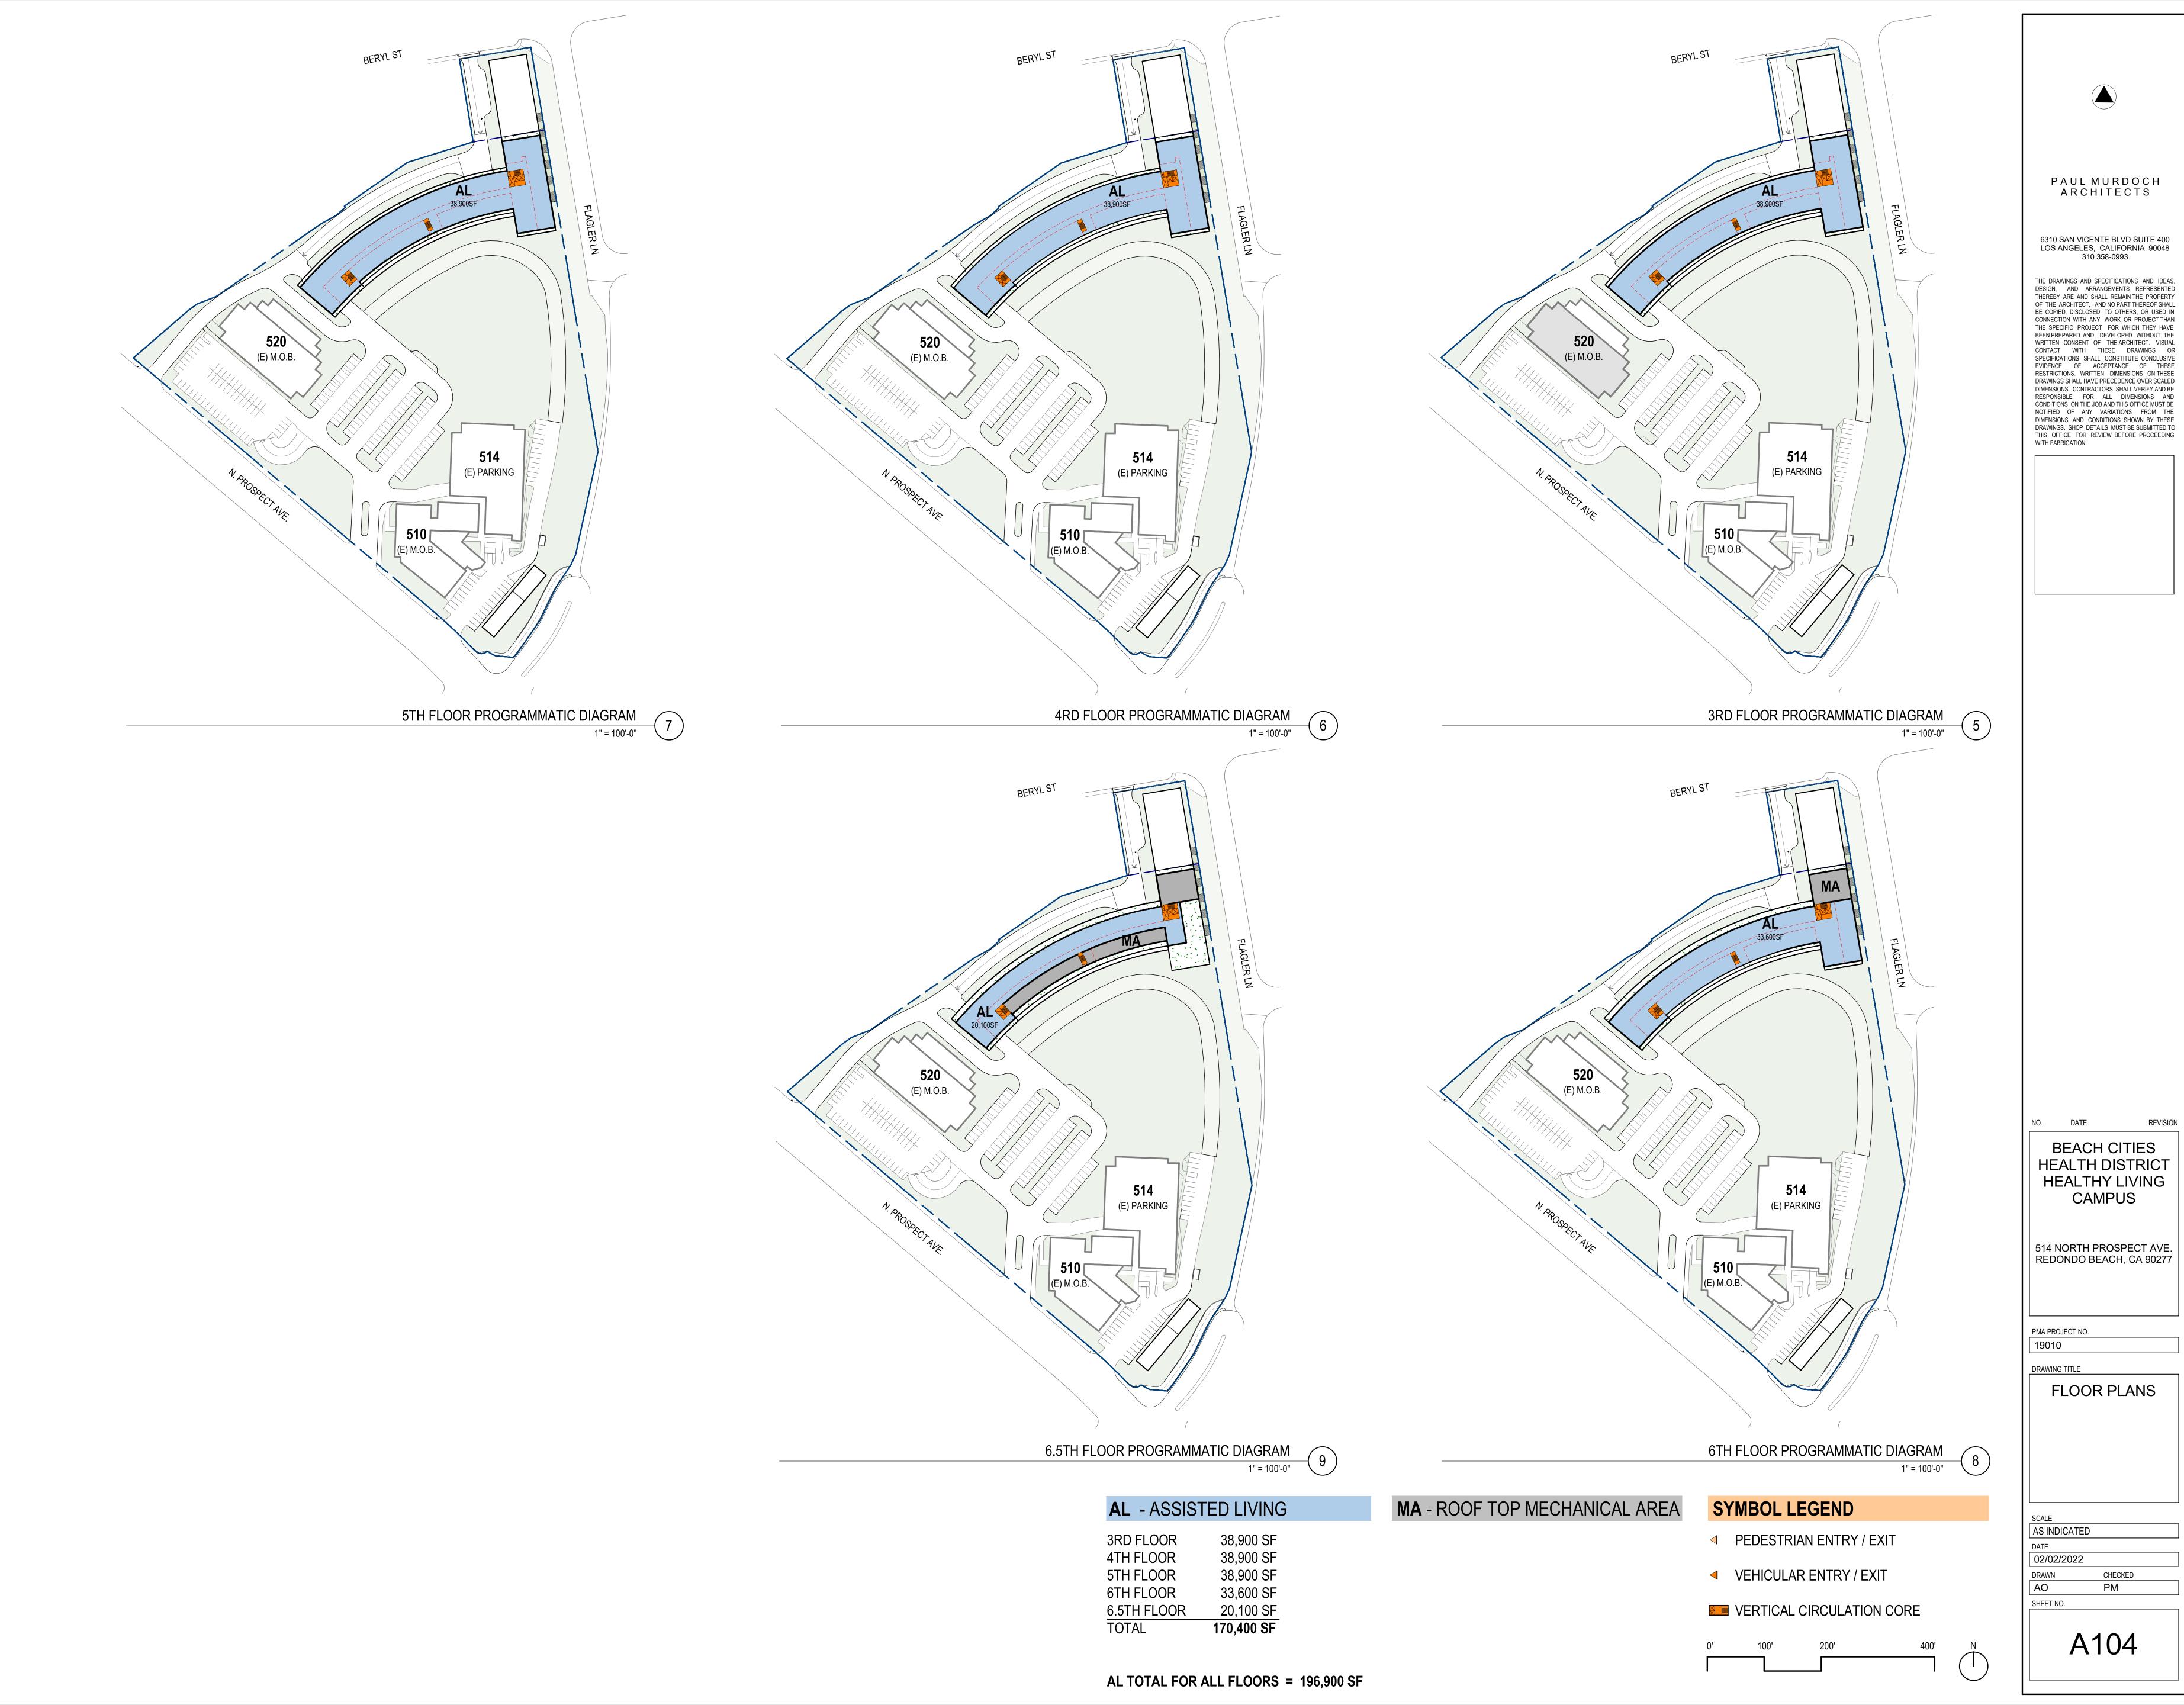
OPEN SPACE SITE PLAN


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SHEET NO.

DATE 02/02/2022 CHECKED PM





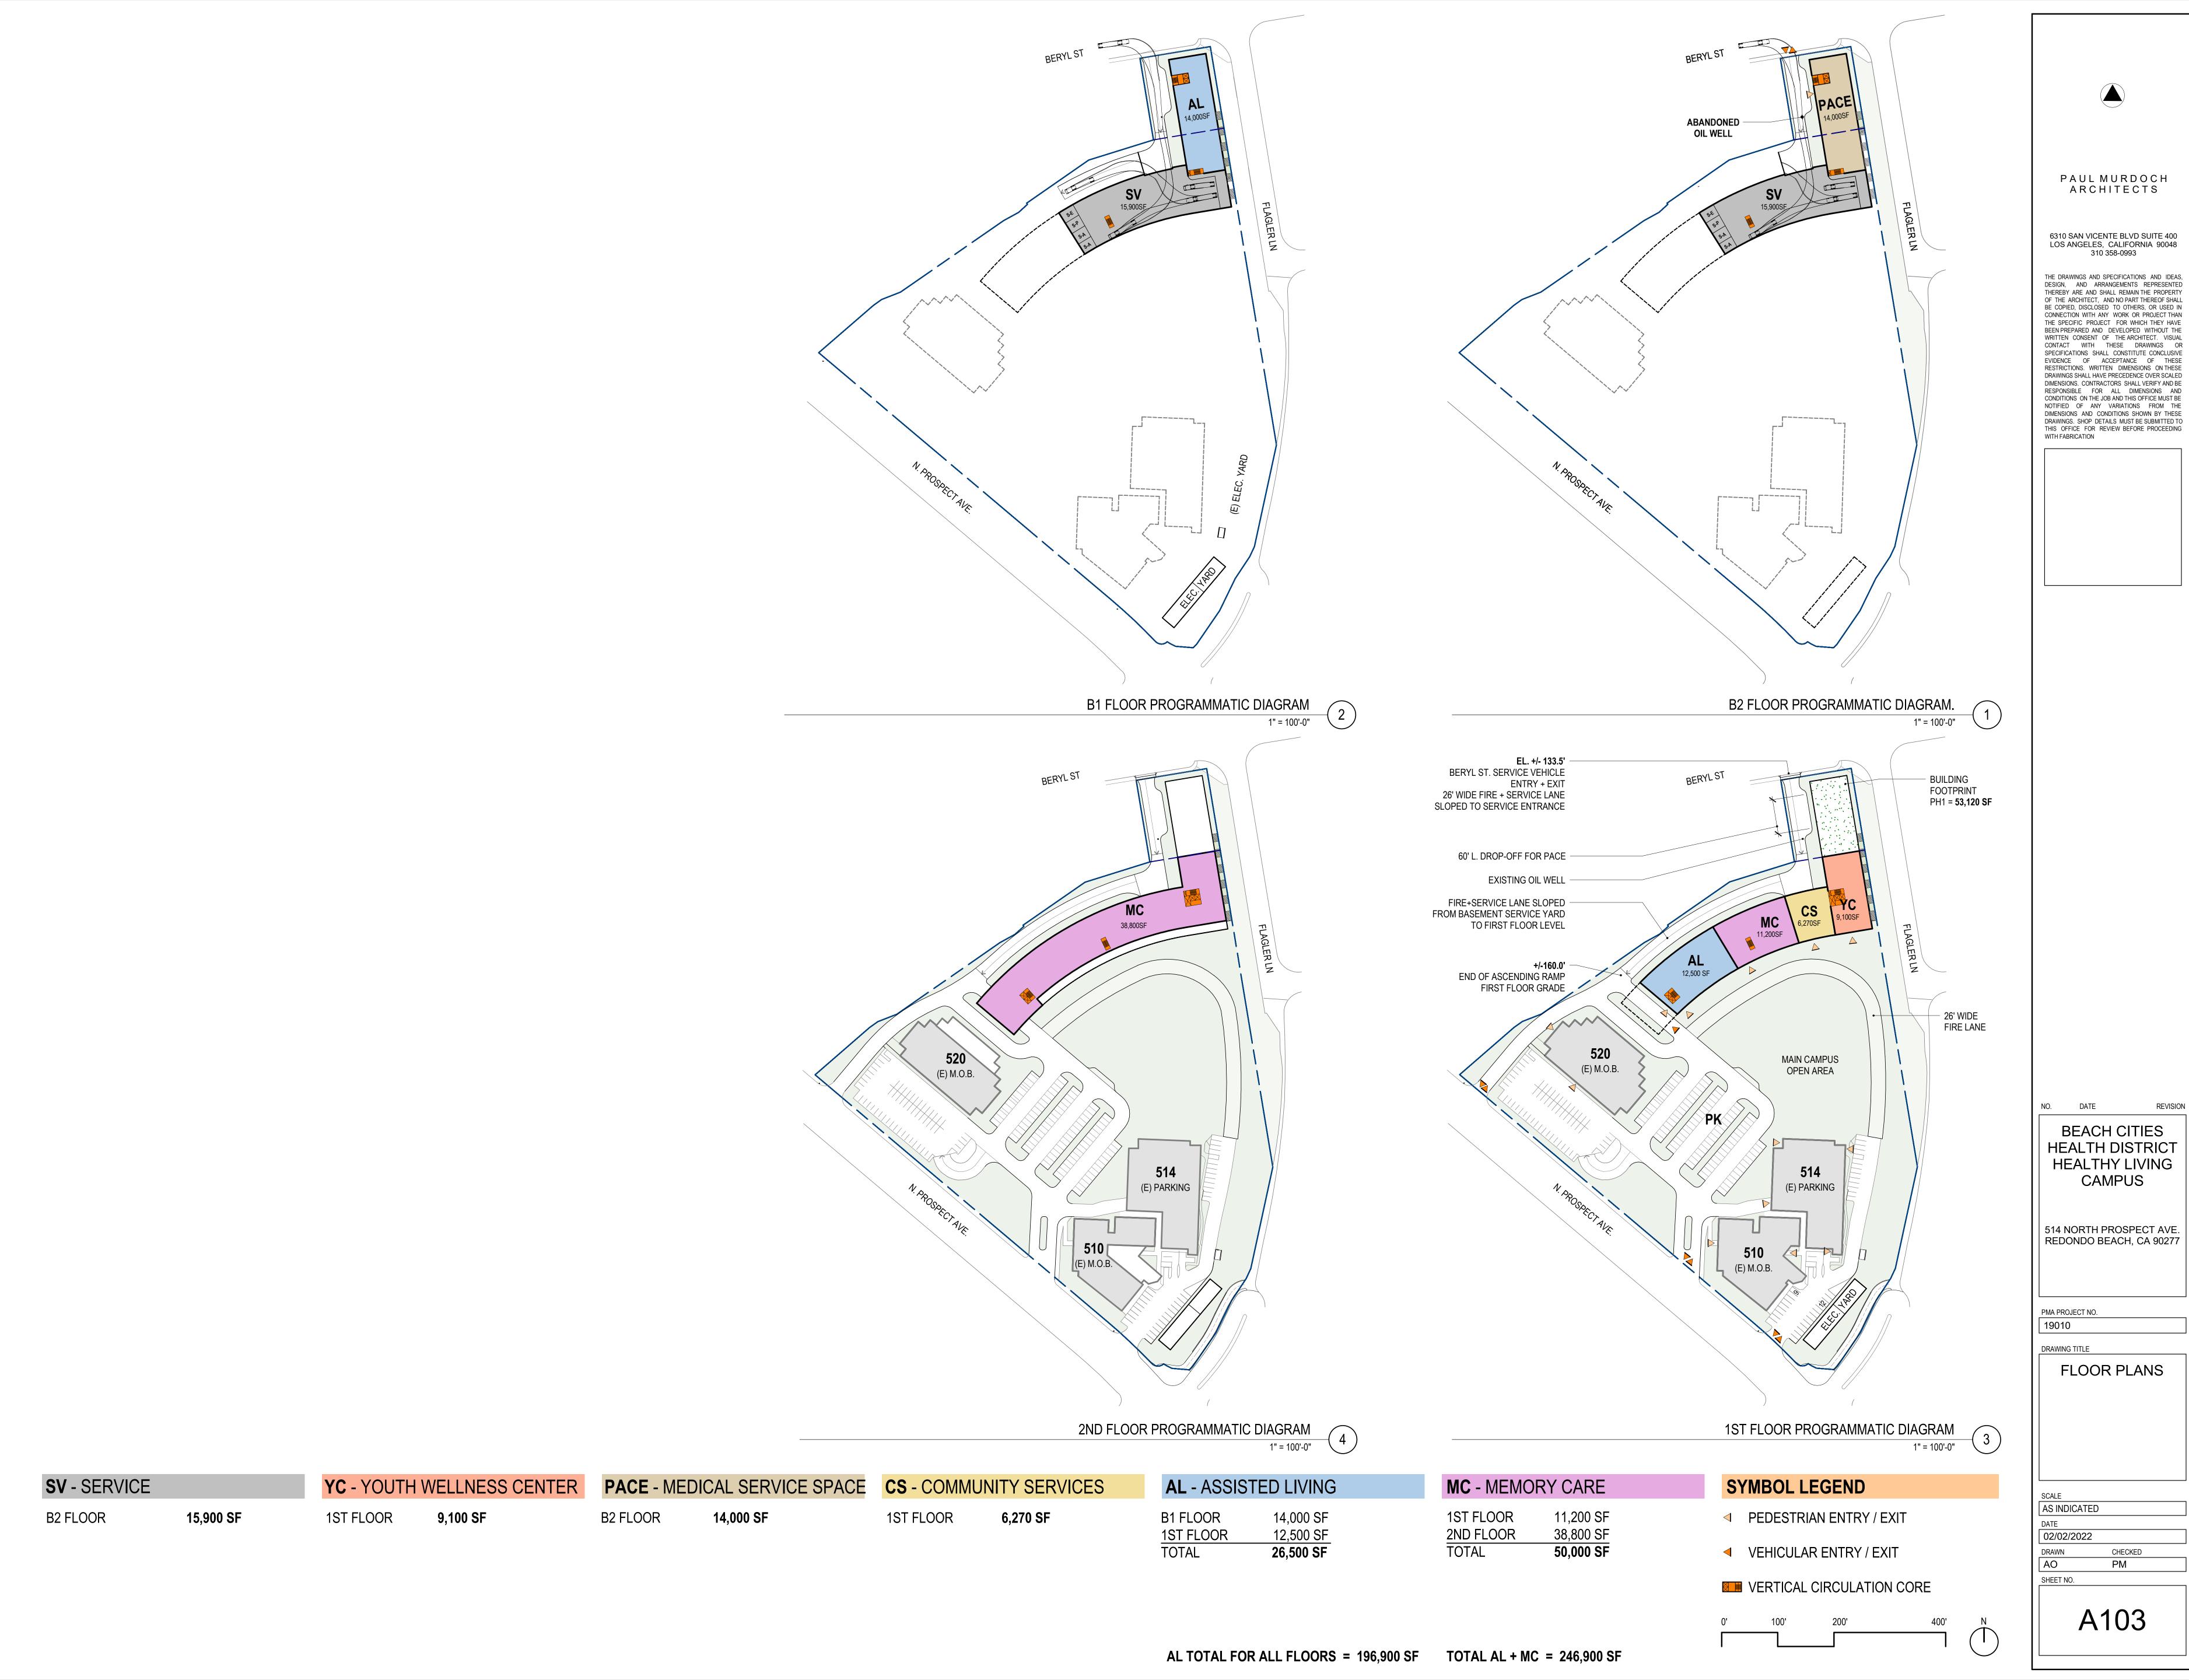

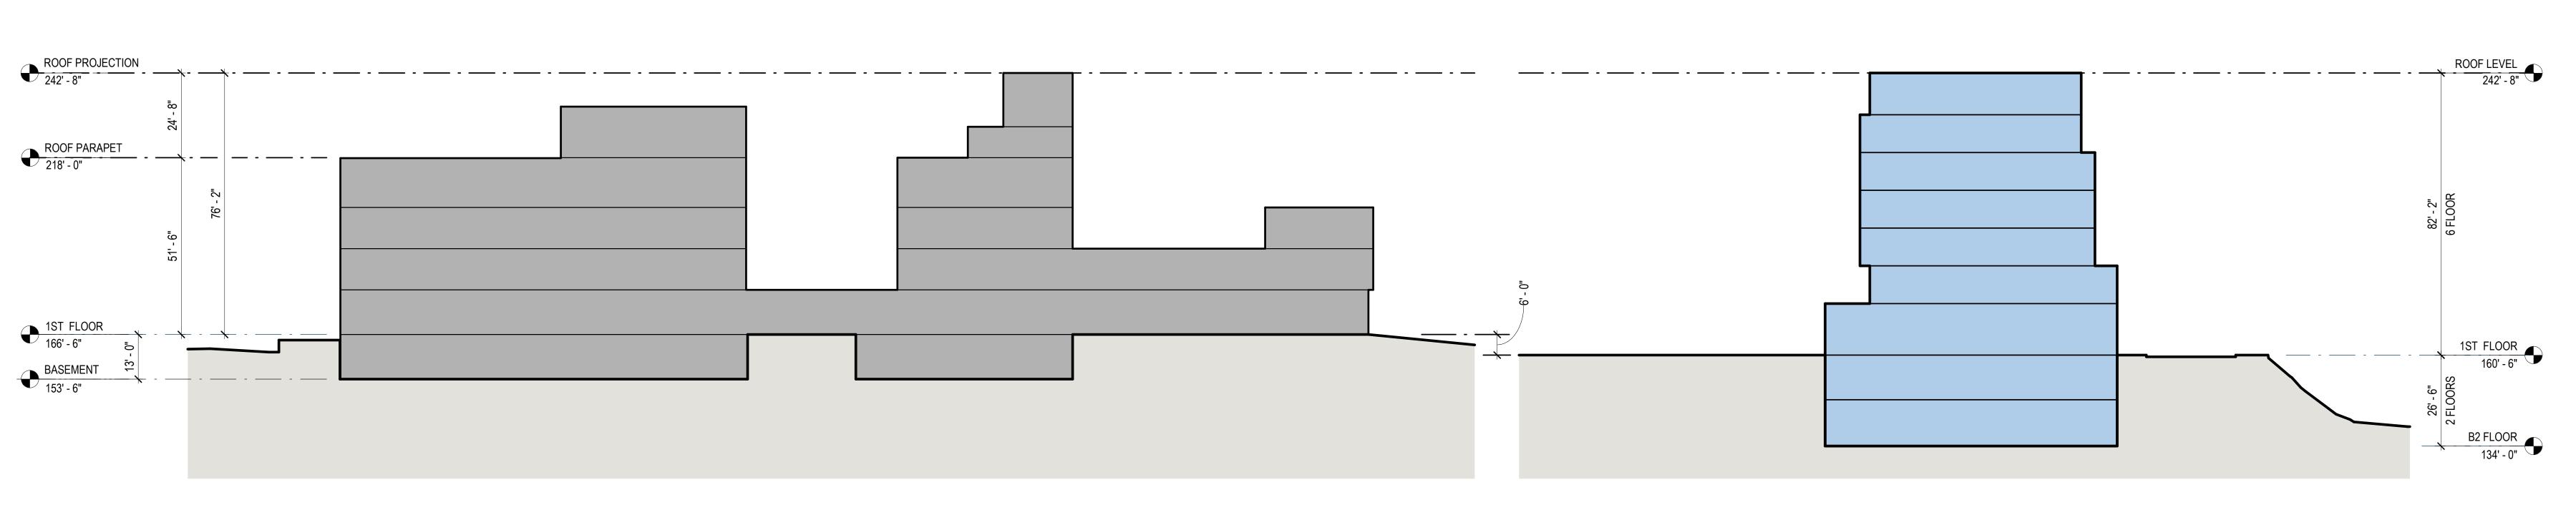EXISTING 514 BUILDING PROPOSED BUILDING

PAUL MURDOCH ARCHITECTS 6310 SAN VICENTE BLVD SUITE 400 LOS ANGELES, CALIFORNIA 90048 310 358-0993 THE DRAWINGS AND SPECIFICATIONS AND IDEAS, DESIGN, AND ARRANGEMENTS REPRESENTED THEREBY ARE AND SHALL REMAIN THE PROPERTY OF THE ARCHITECT, AND NO PART THEREOF SHALL BE COPIED, DISCLOSED TO OTHERS, OR USED IN CONNECTION WITH ANY WORK OR PROJECT THAN THE SPECIFIC PROJECT FOR WHICH THEY HAVE BEEN PREPARED AND DEVELOPED WITHOUT THE WRITTEN CONSENT OF THE ARCHITECT. VISUAL CONTACT WITH THESE DRAWINGS OR SPECIFICATIONS SHALL CONSTITUTE CONCLUSIVE EVIDENCE OF ACCEPTANCE OF THESE RESTRICTIONS. WRITTEN DIMENSIONS ON THESE DRAWINGS SHALL HAVE PRECEDENCE OVER SCALED DIMENSIONS. CONTRACTORS SHALL VERIFY AND BE RESPONSIBLE FOR ALL DIMENSIONS AND CONDITIONS ON THE JOB AND THIS OFFICE MUST BE NOTIFIED OF ANY VARIATIONS FROM THE DIMENSIONS AND CONDITIONS SHOWN BY THESE DRAWINGS. SHOP DETAILS MUST BE SUBMITTED TO THIS OFFICE FOR REVIEW BEFORE PROCEEDING WITH FABRICATION NO. DATE


BEACH CITIES
HEALTH DISTRICT
HEALTHY LIVING CAMPUS


514 NORTH PROSPECT AVE. REDONDO BEACH, CA 90277


PMA PROJECT NO.

DRAWING TITLE COMPARATIVE SECTIONS

SCALE 1" = 20'-0" DATE 02/02/2022 PM

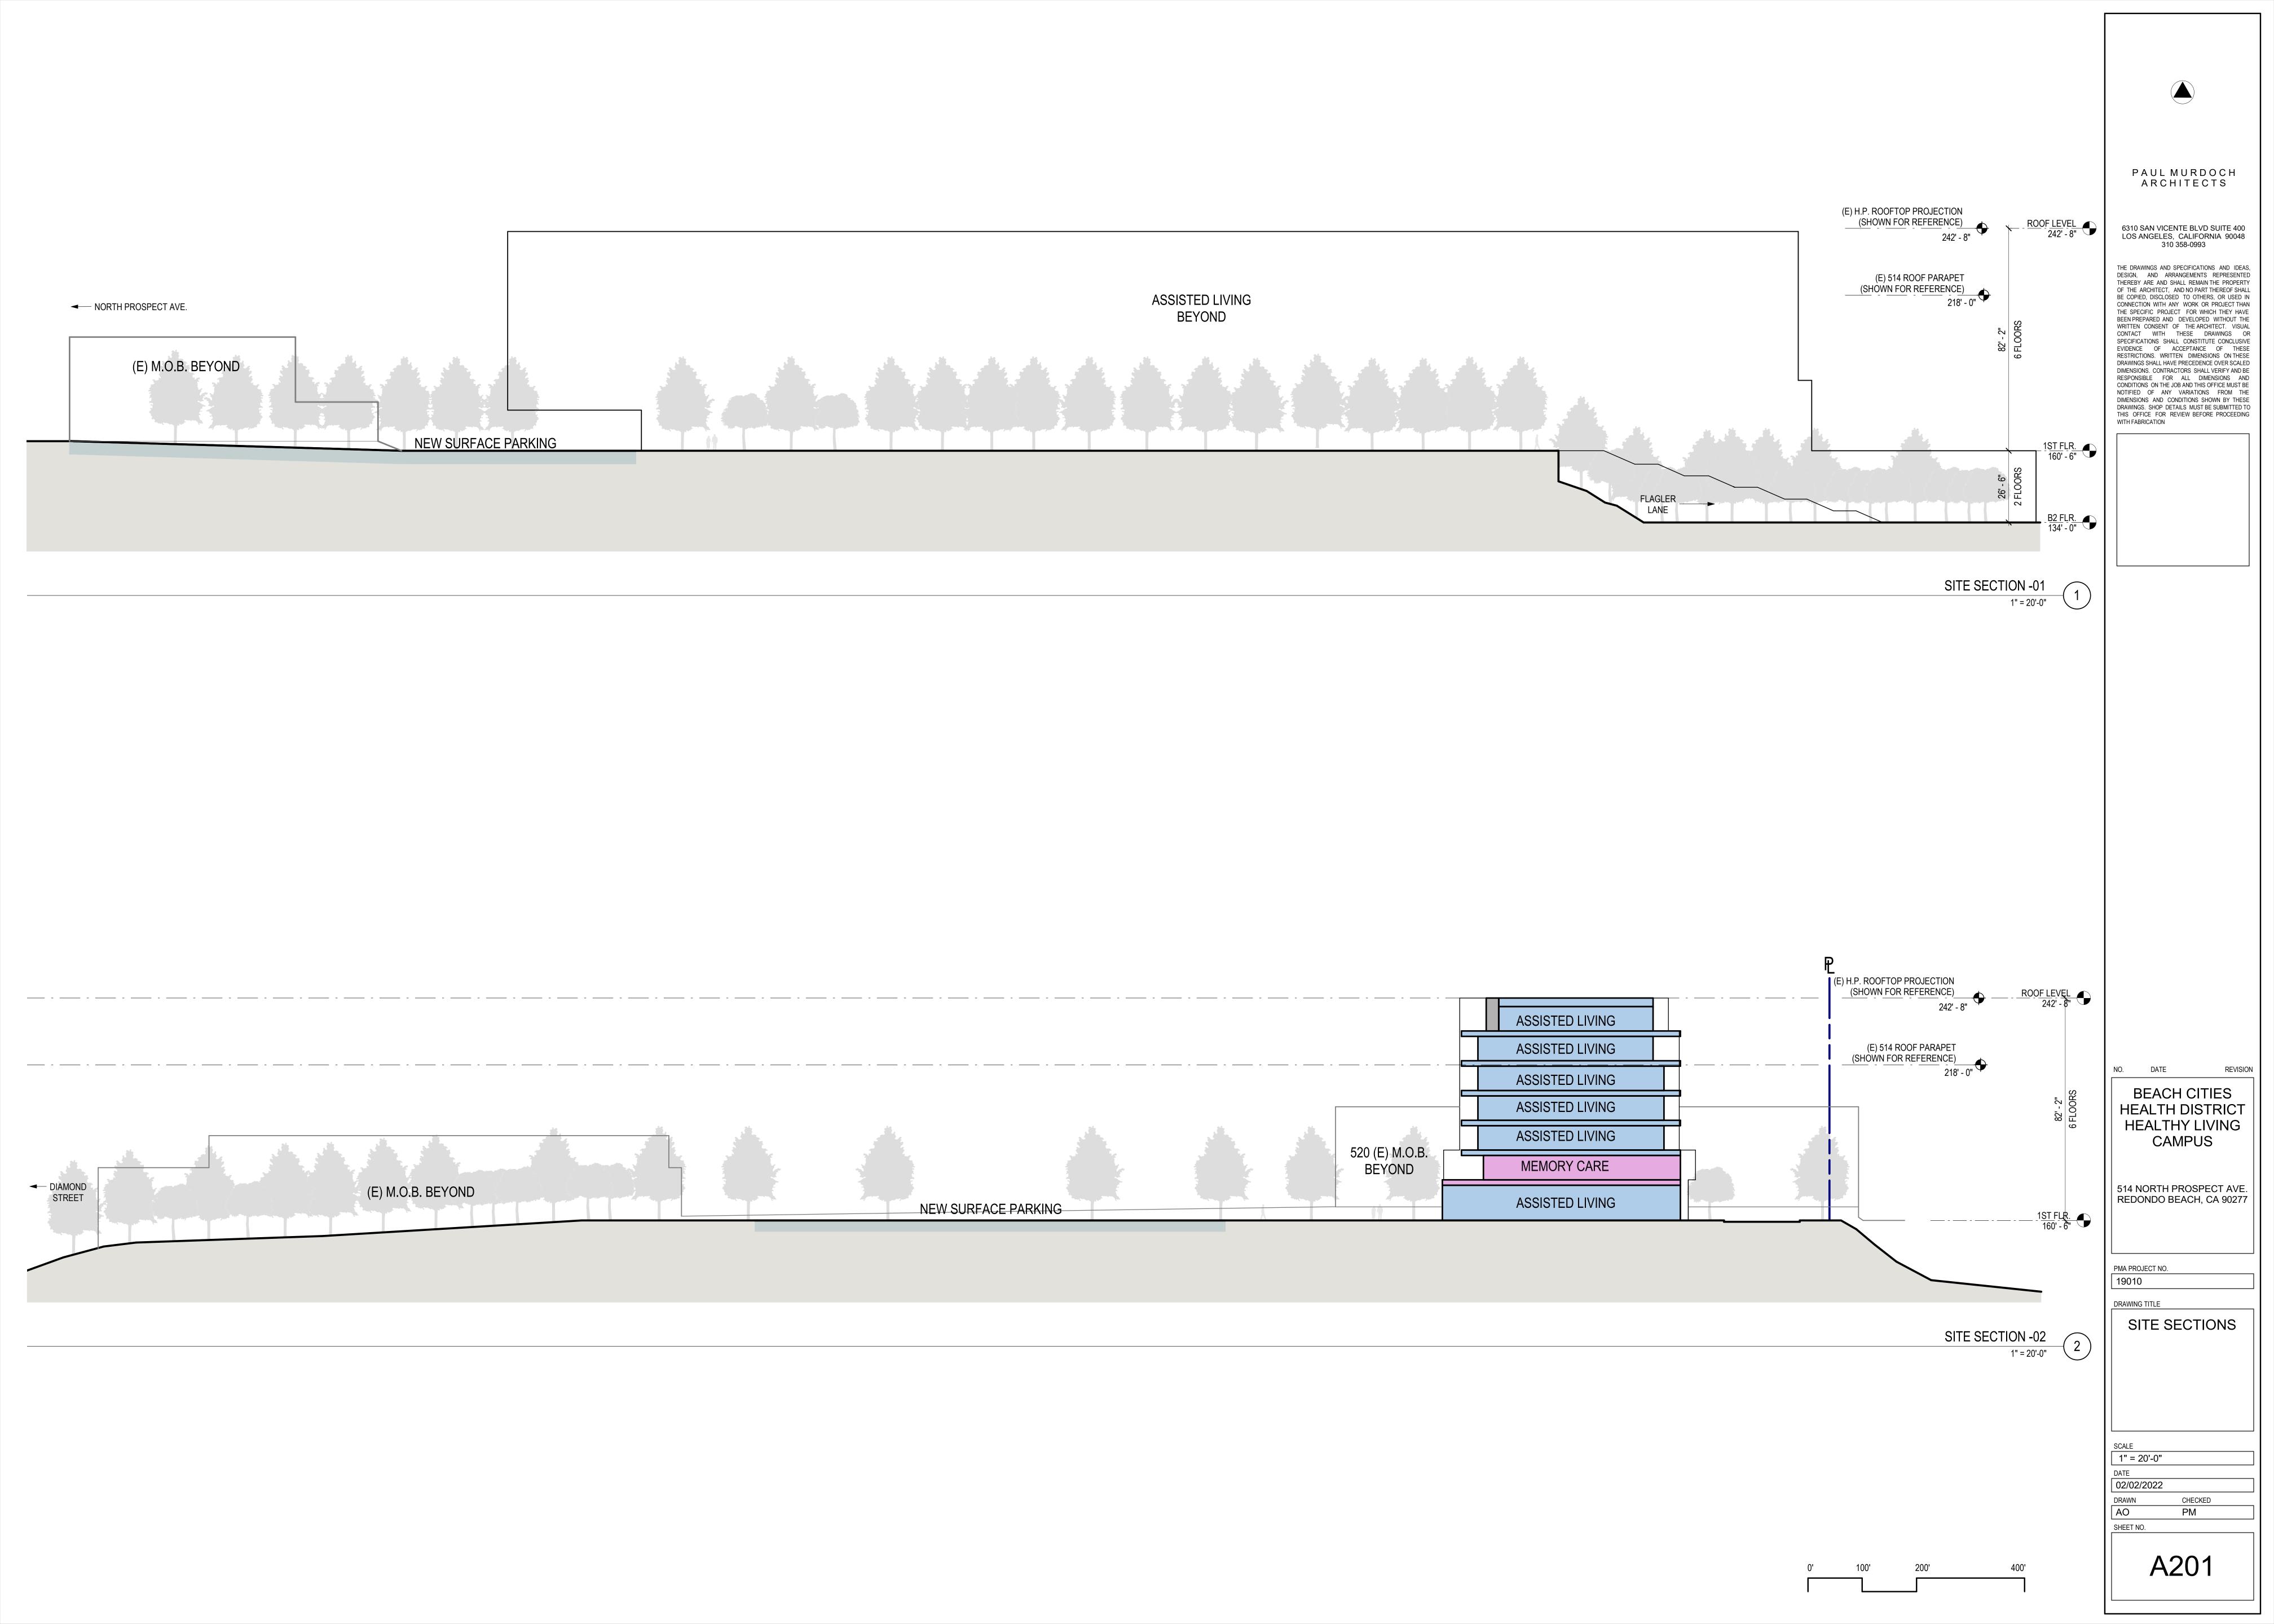

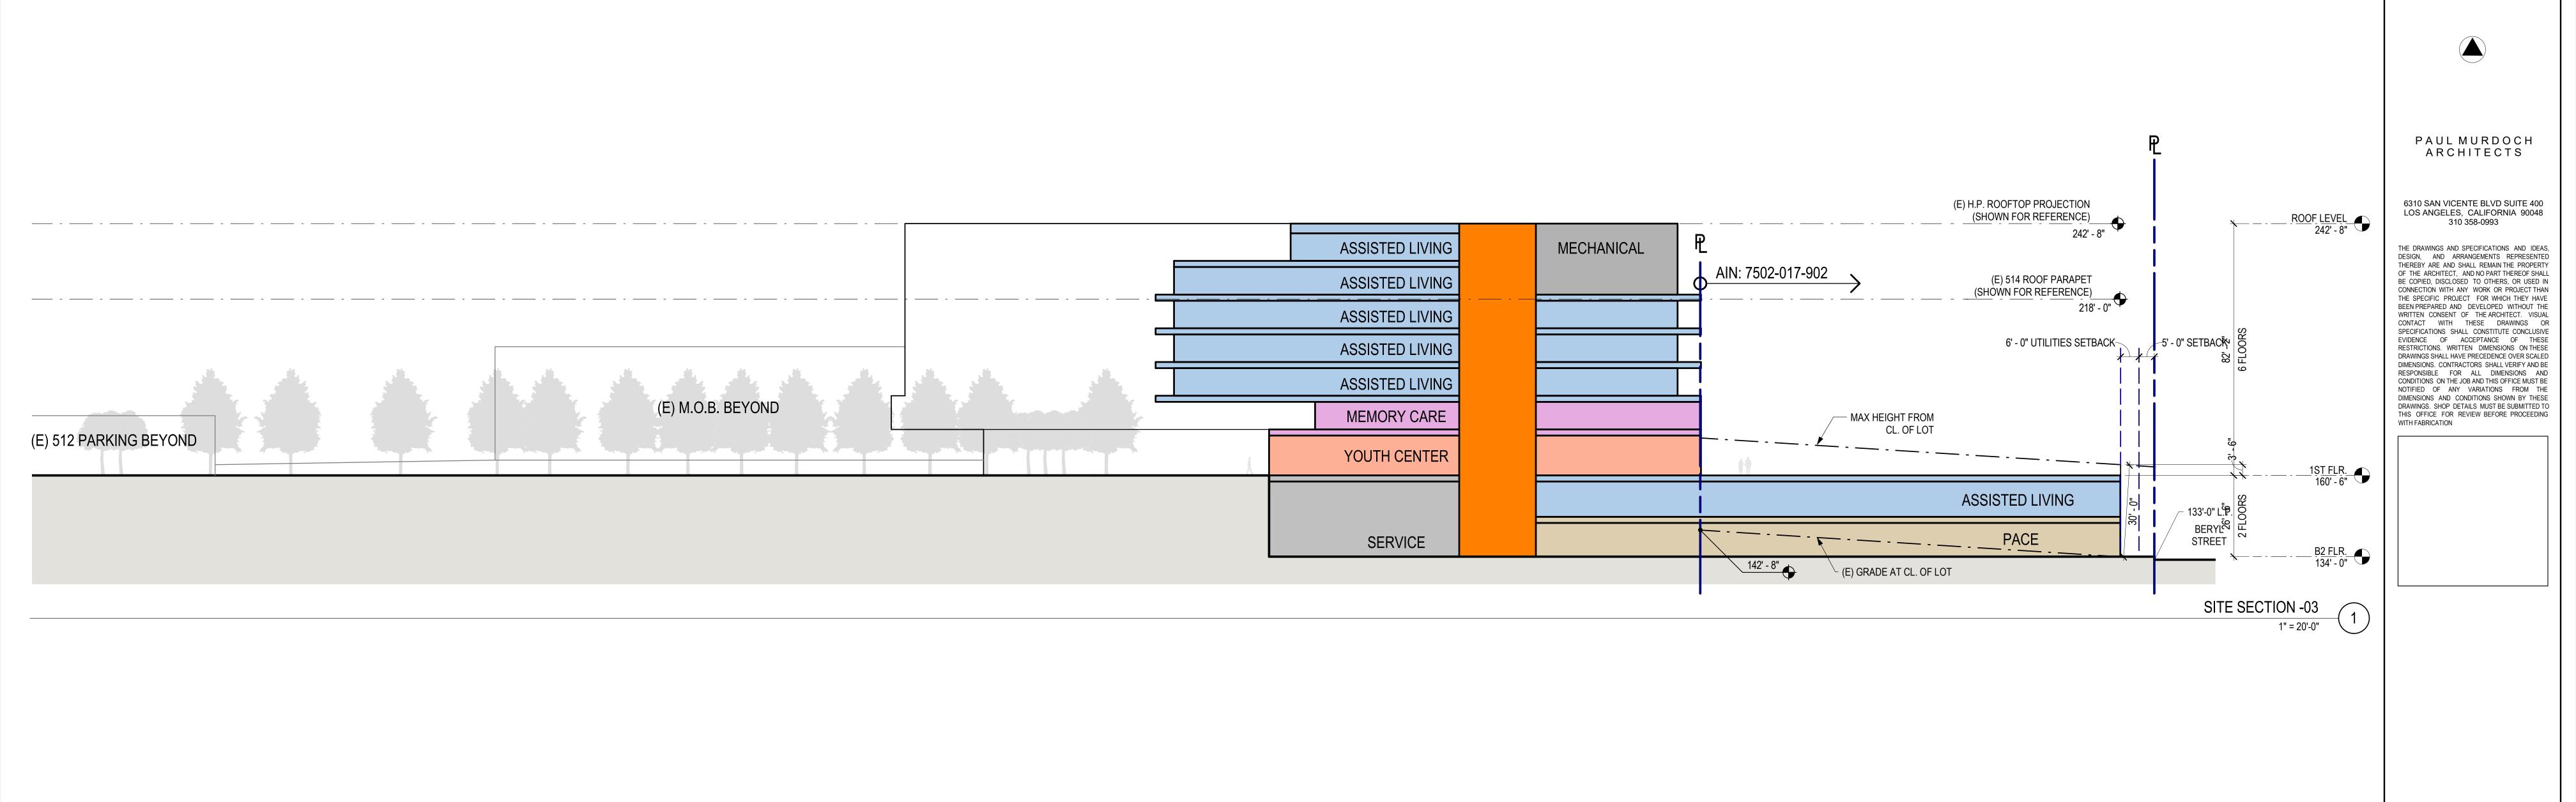

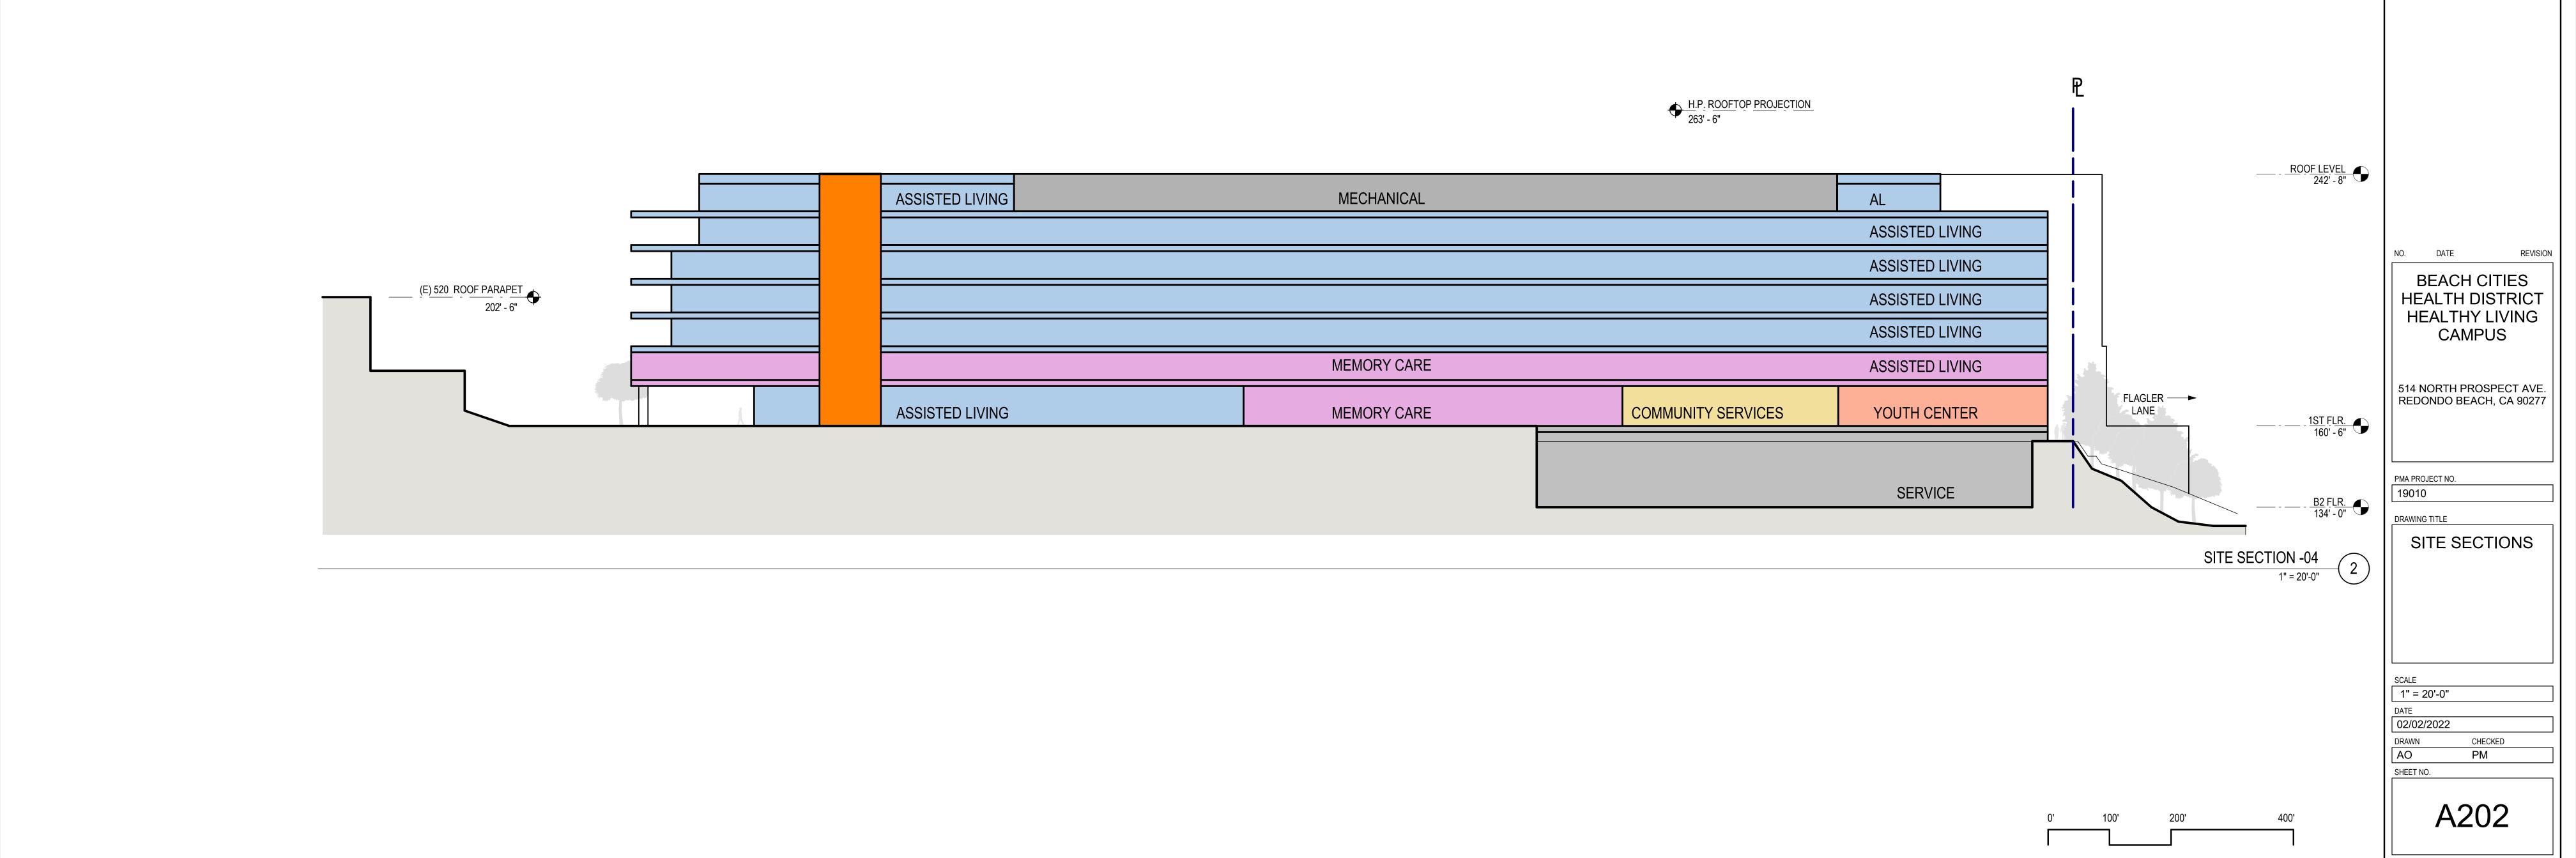



6310 SAN VICENTE BLVD SUITE 400 LOS ANGELES, CALIFORNIA 90048 310 358-0993

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BEACH CITIES
HEALTH DISTRICT
HEALTHY LIVING
CAMPUS

514 NORTH PROSPECT AVE. REDONDO BEACH, CA 90277

PMA PROJECT NO.

DRAWING TITLE

EXISTING NORTHEAST 3D MASSING VIEW

CALE


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SHEET NO.



6310 SAN VICENTE BLVD SUITE 400 LOS ANGELES, CALIFORNIA 90048 310 358-0993

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BEACH CITIES
HEALTH DISTRICT
HEALTHY LIVING
CAMPUS

514 NORTH PROSPECT AVE. REDONDO BEACH, CA 90277

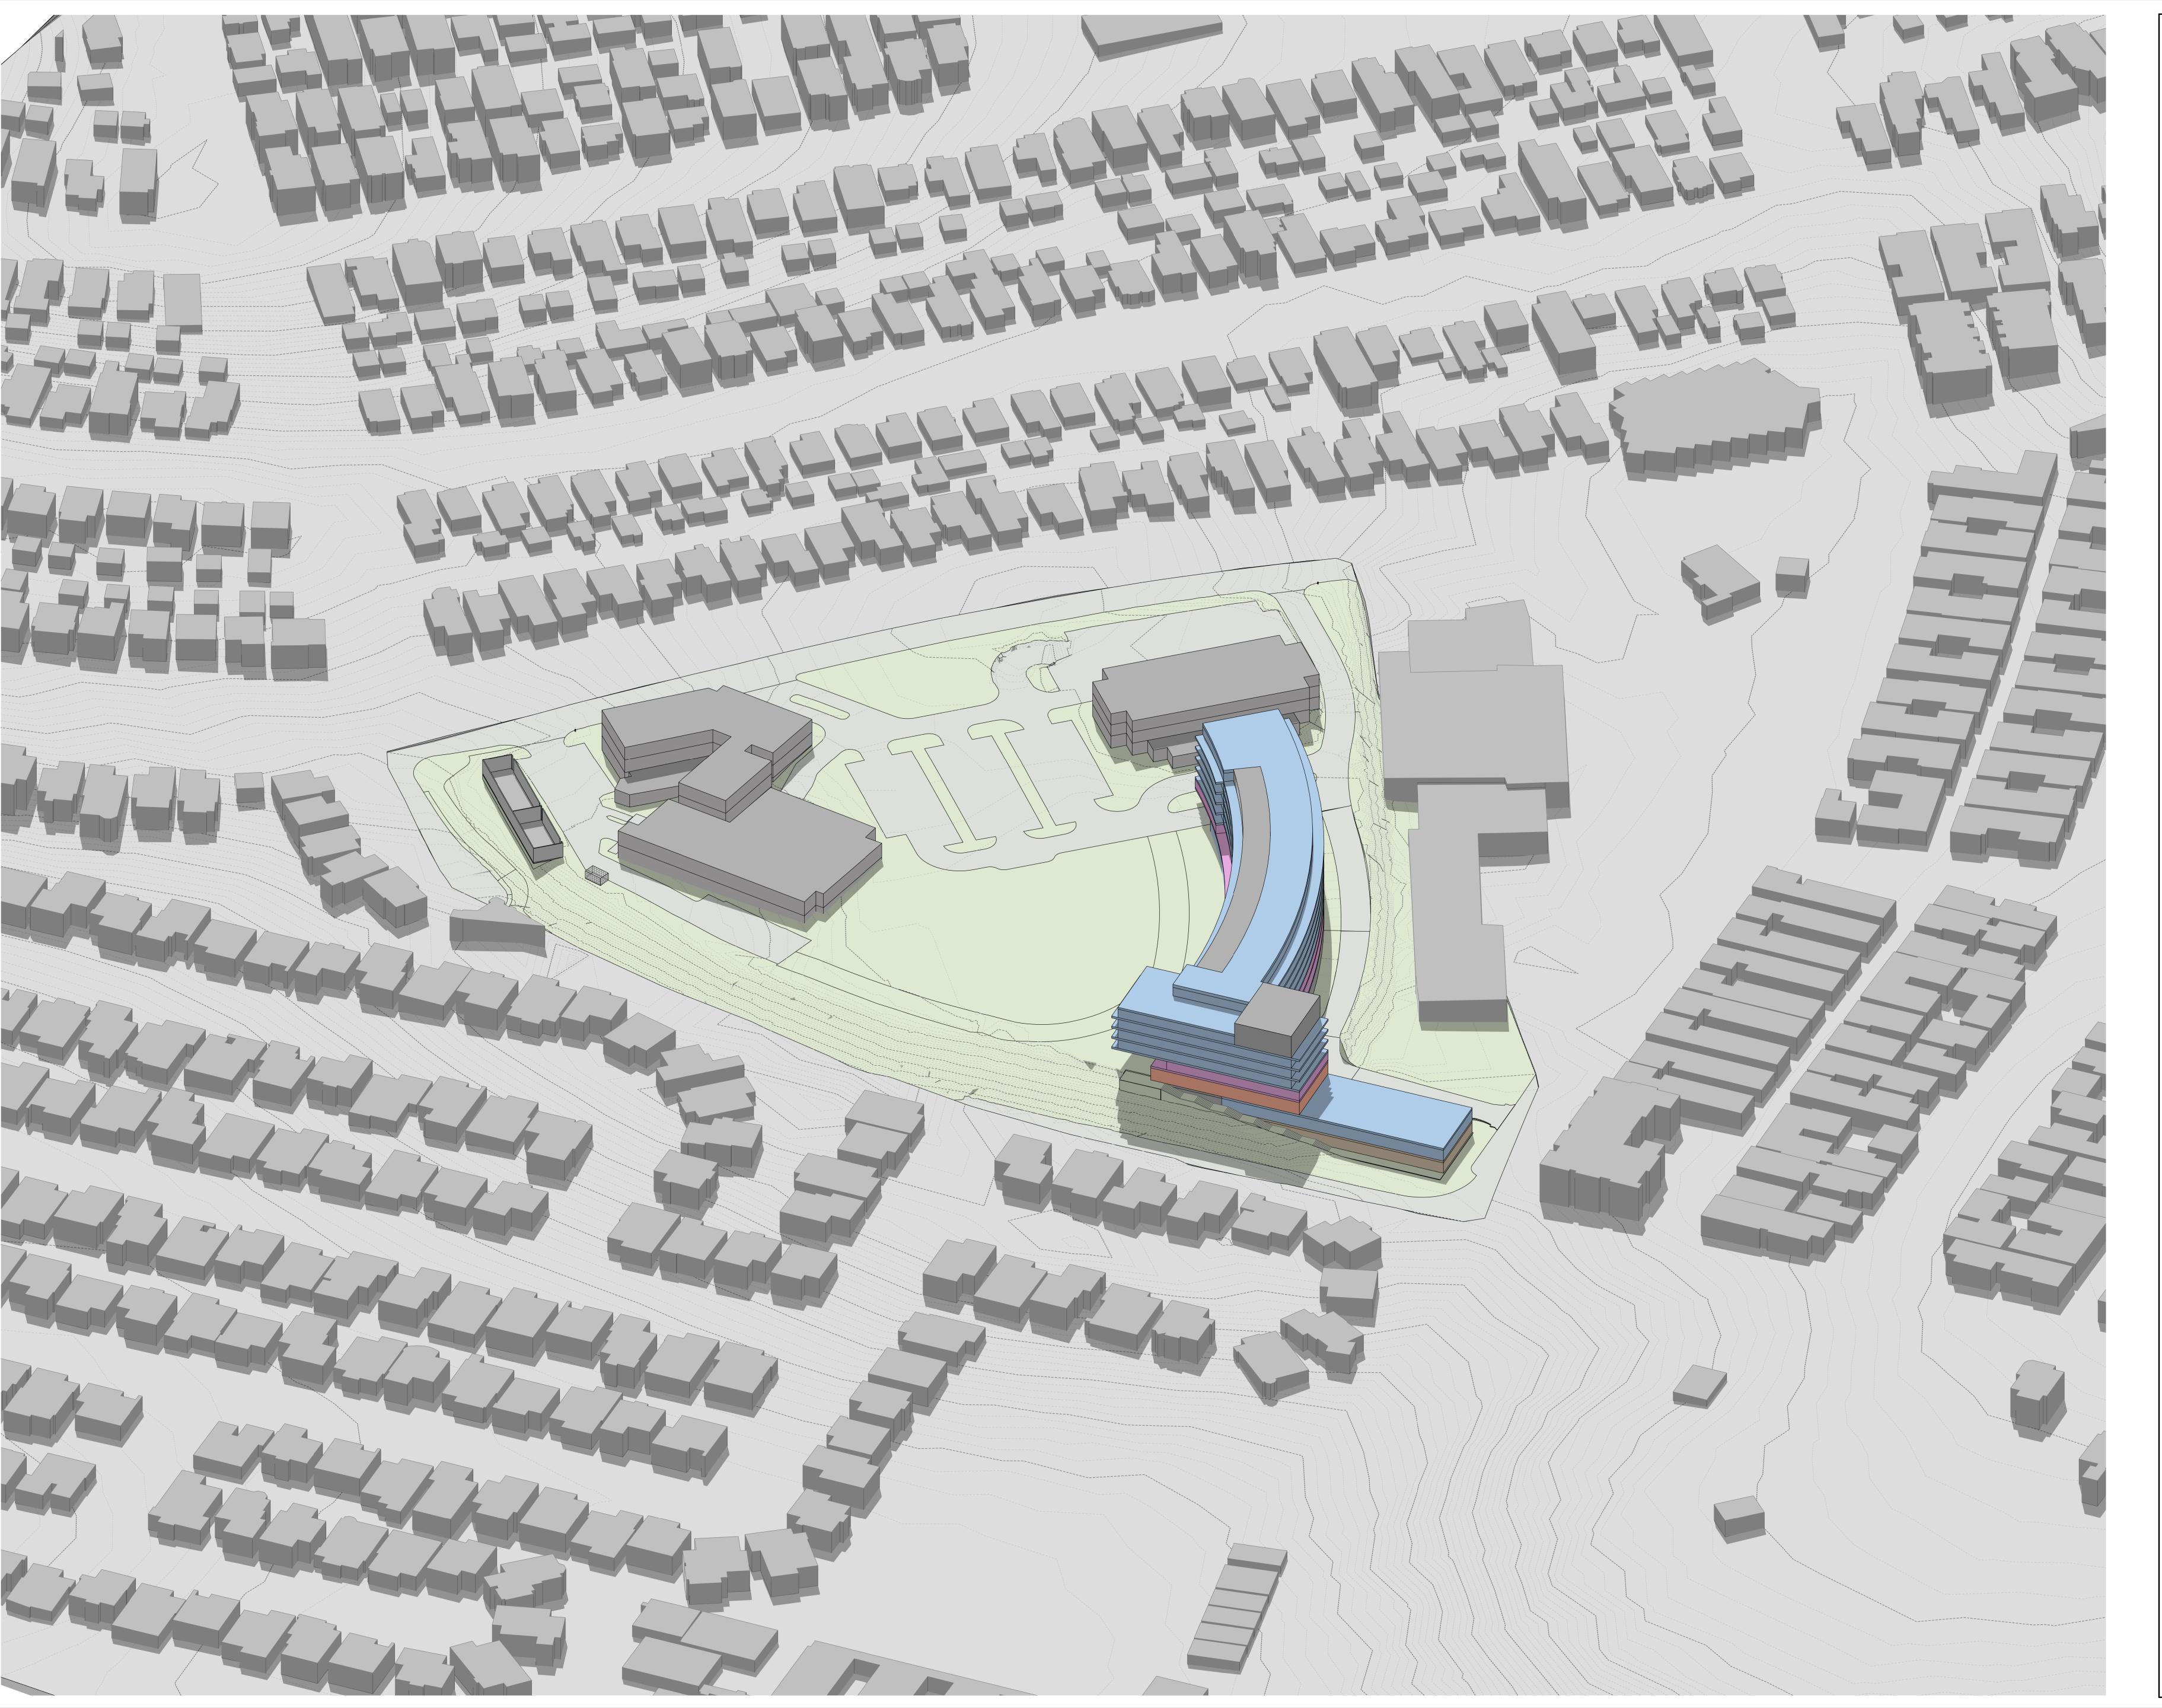PMA PROJECT NO.

DRAWING TITLE

NORTHEAST 3D MASSING VIEW

CALE

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BEACH CITIES
HEALTH DISTRICT
HEALTHY LIVING
CAMPUS

514 NORTH PROSPECT AVE. REDONDO BEACH, CA 90277

DRAWING TITLE

NORTHWEST 3D MASSING VIEW

DATE
02/02/2022
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SHEET NO. CHECKED PM



6310 SAN VICENTE BLVD SUITE 400 LOS ANGELES, CALIFORNIA 90048 310 358-0993

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BEACH CITIES
HEALTH DISTRICT
HEALTHY LIVING
CAMPUS

514 NORTH PROSPECT AVE. REDONDO BEACH, CA 90277

19010


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SOUTHEAST 3D MASSING VIEW

SCALE

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6310 SAN VICENTE BLVD SUITE 400 LOS ANGELES, CALIFORNIA 90048 310 358-0993

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BEACH CITIES
HEALTH DISTRICT
HEALTHY LIVING
CAMPUS

514 NORTH PROSPECT AVE. REDONDO BEACH, CA 90277

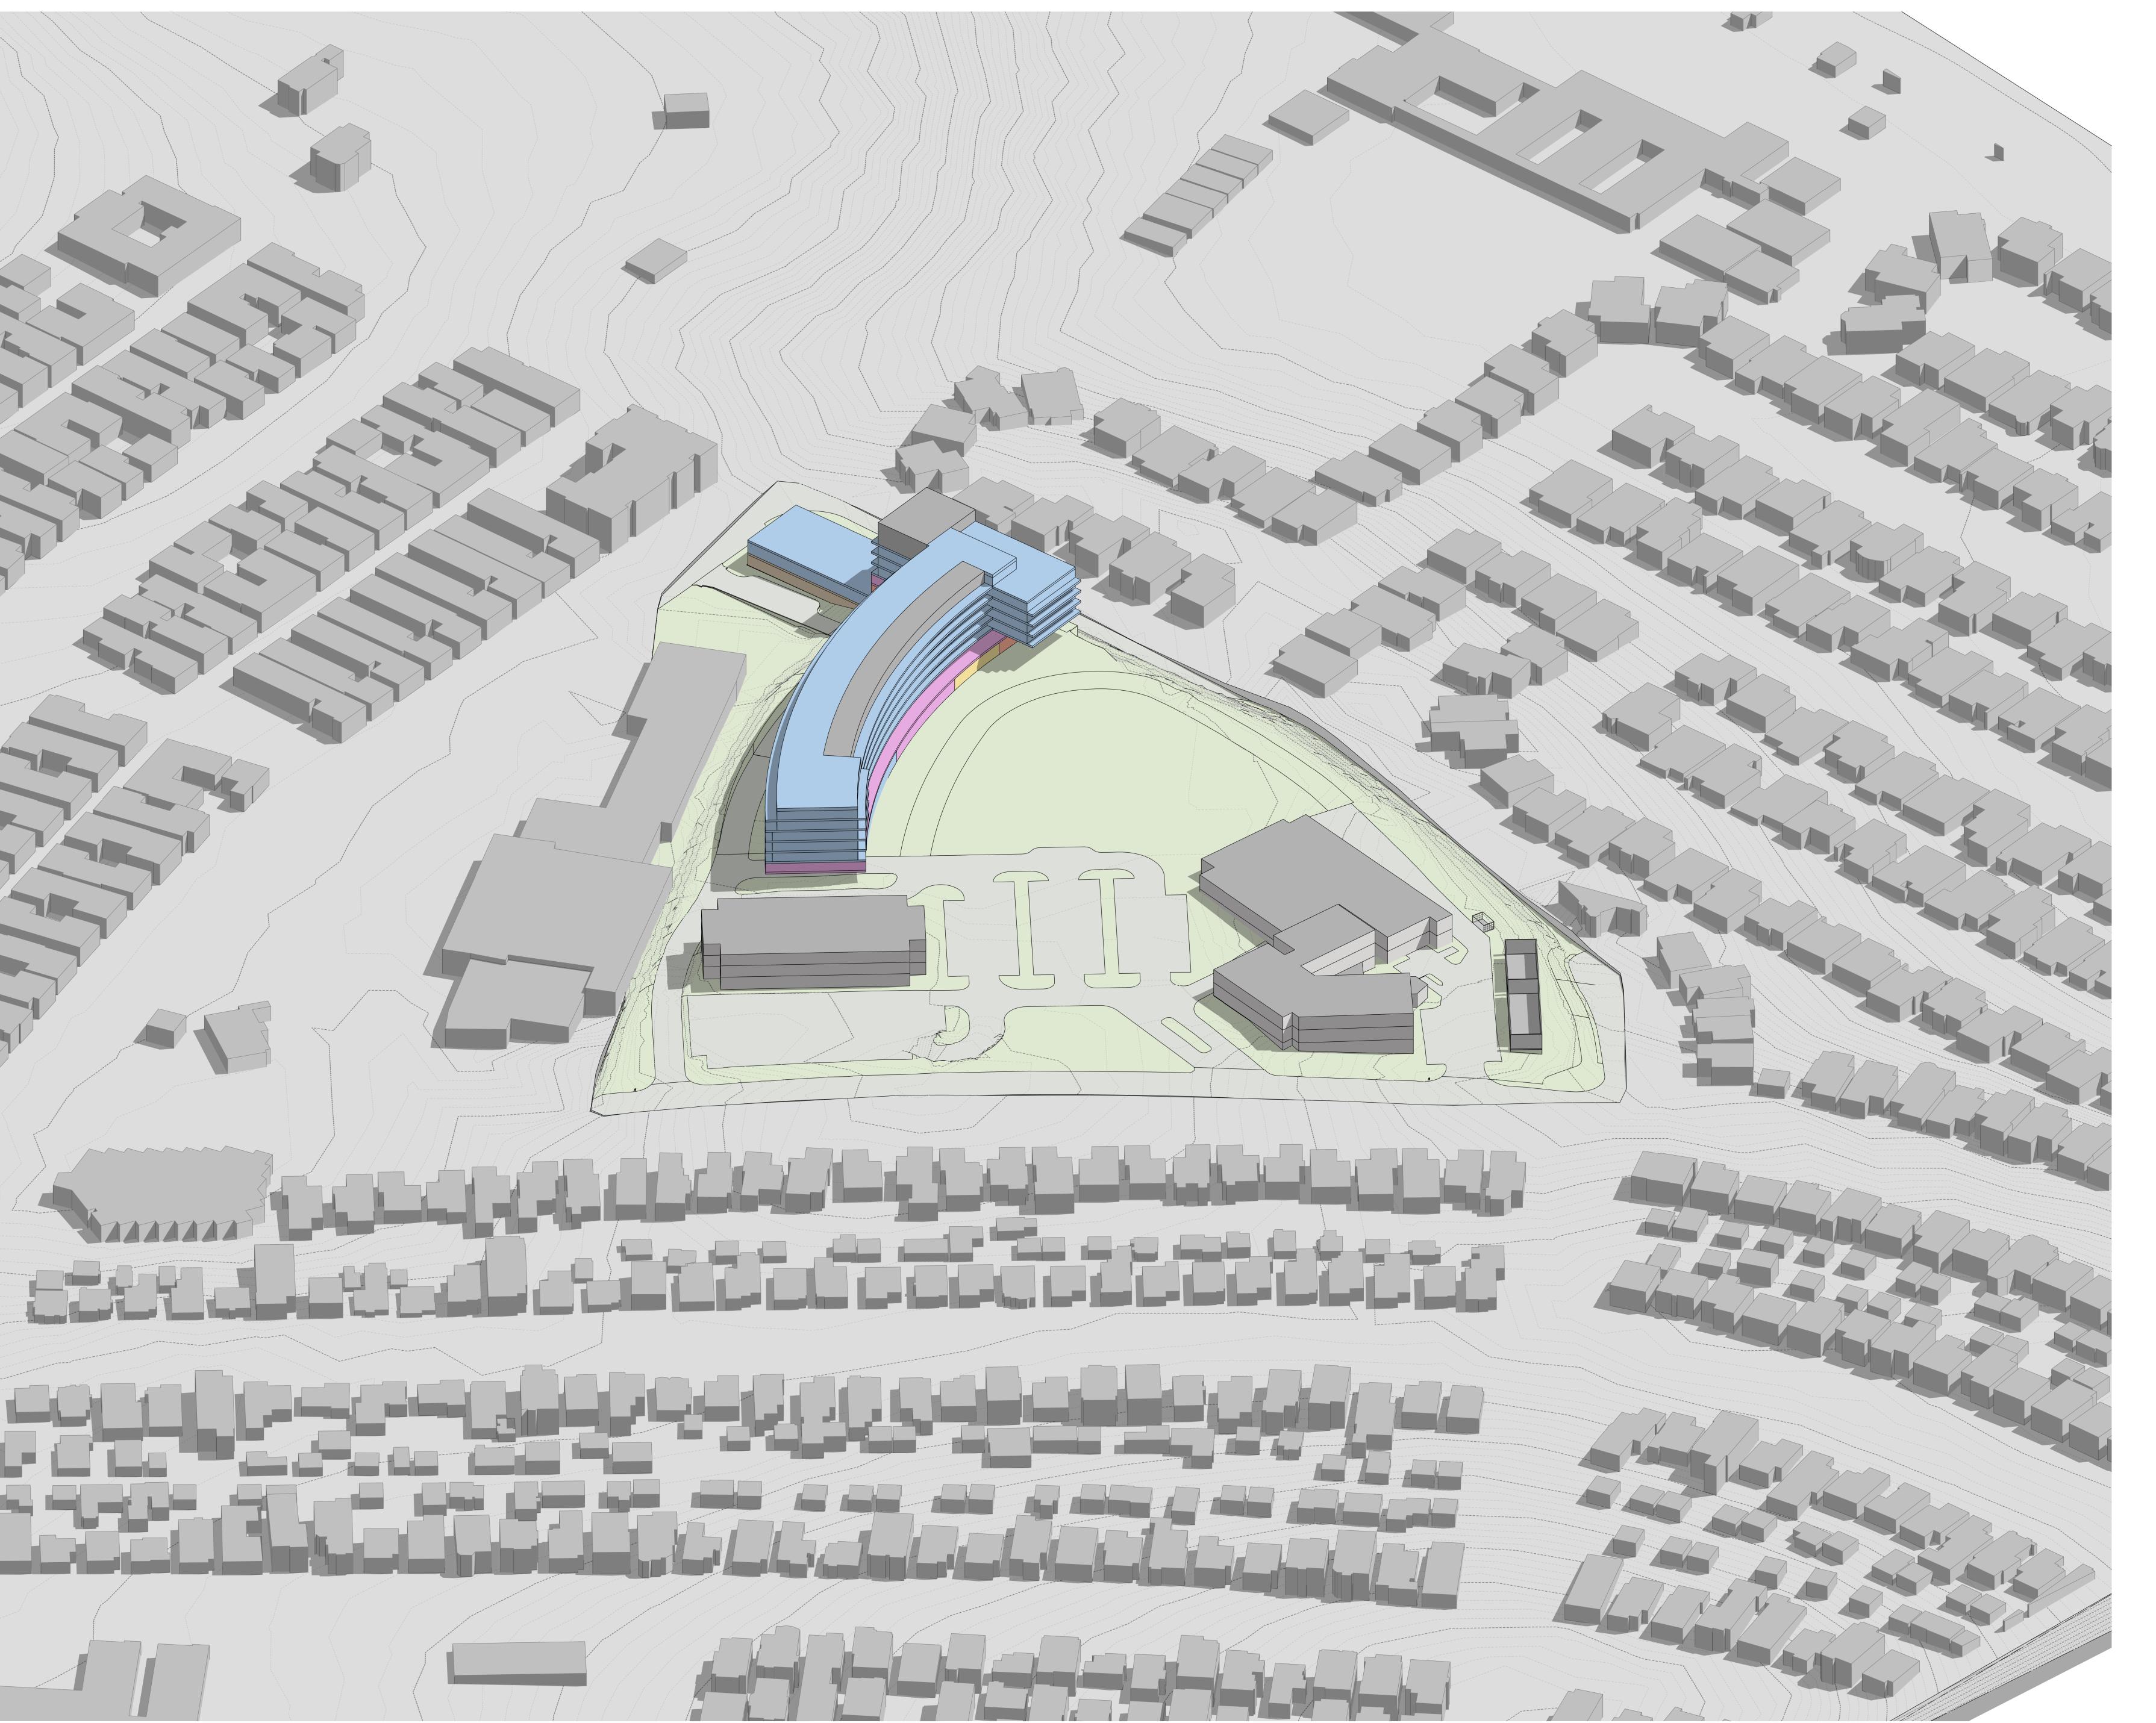PMA PROJECT NO.

DRAWING TITLE

SOUTHWEST 3D MASSING VIEW

EXTERIOR LEGATION - NORTHEAST

EXTEROR ELEVATION - SOUTHEAST
1-32

PAUL MURDOCH ARCHITECTS

6310 SAN VICENTE BLVD SUITE 400 LOS ANGELES, CALIFORNIA 90048 310 358-0993

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HEALTHY LIVING
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514 NORTH PROSPECT AVE. REDONDO BEACH, CA 90277

PMA PROJECT NO.

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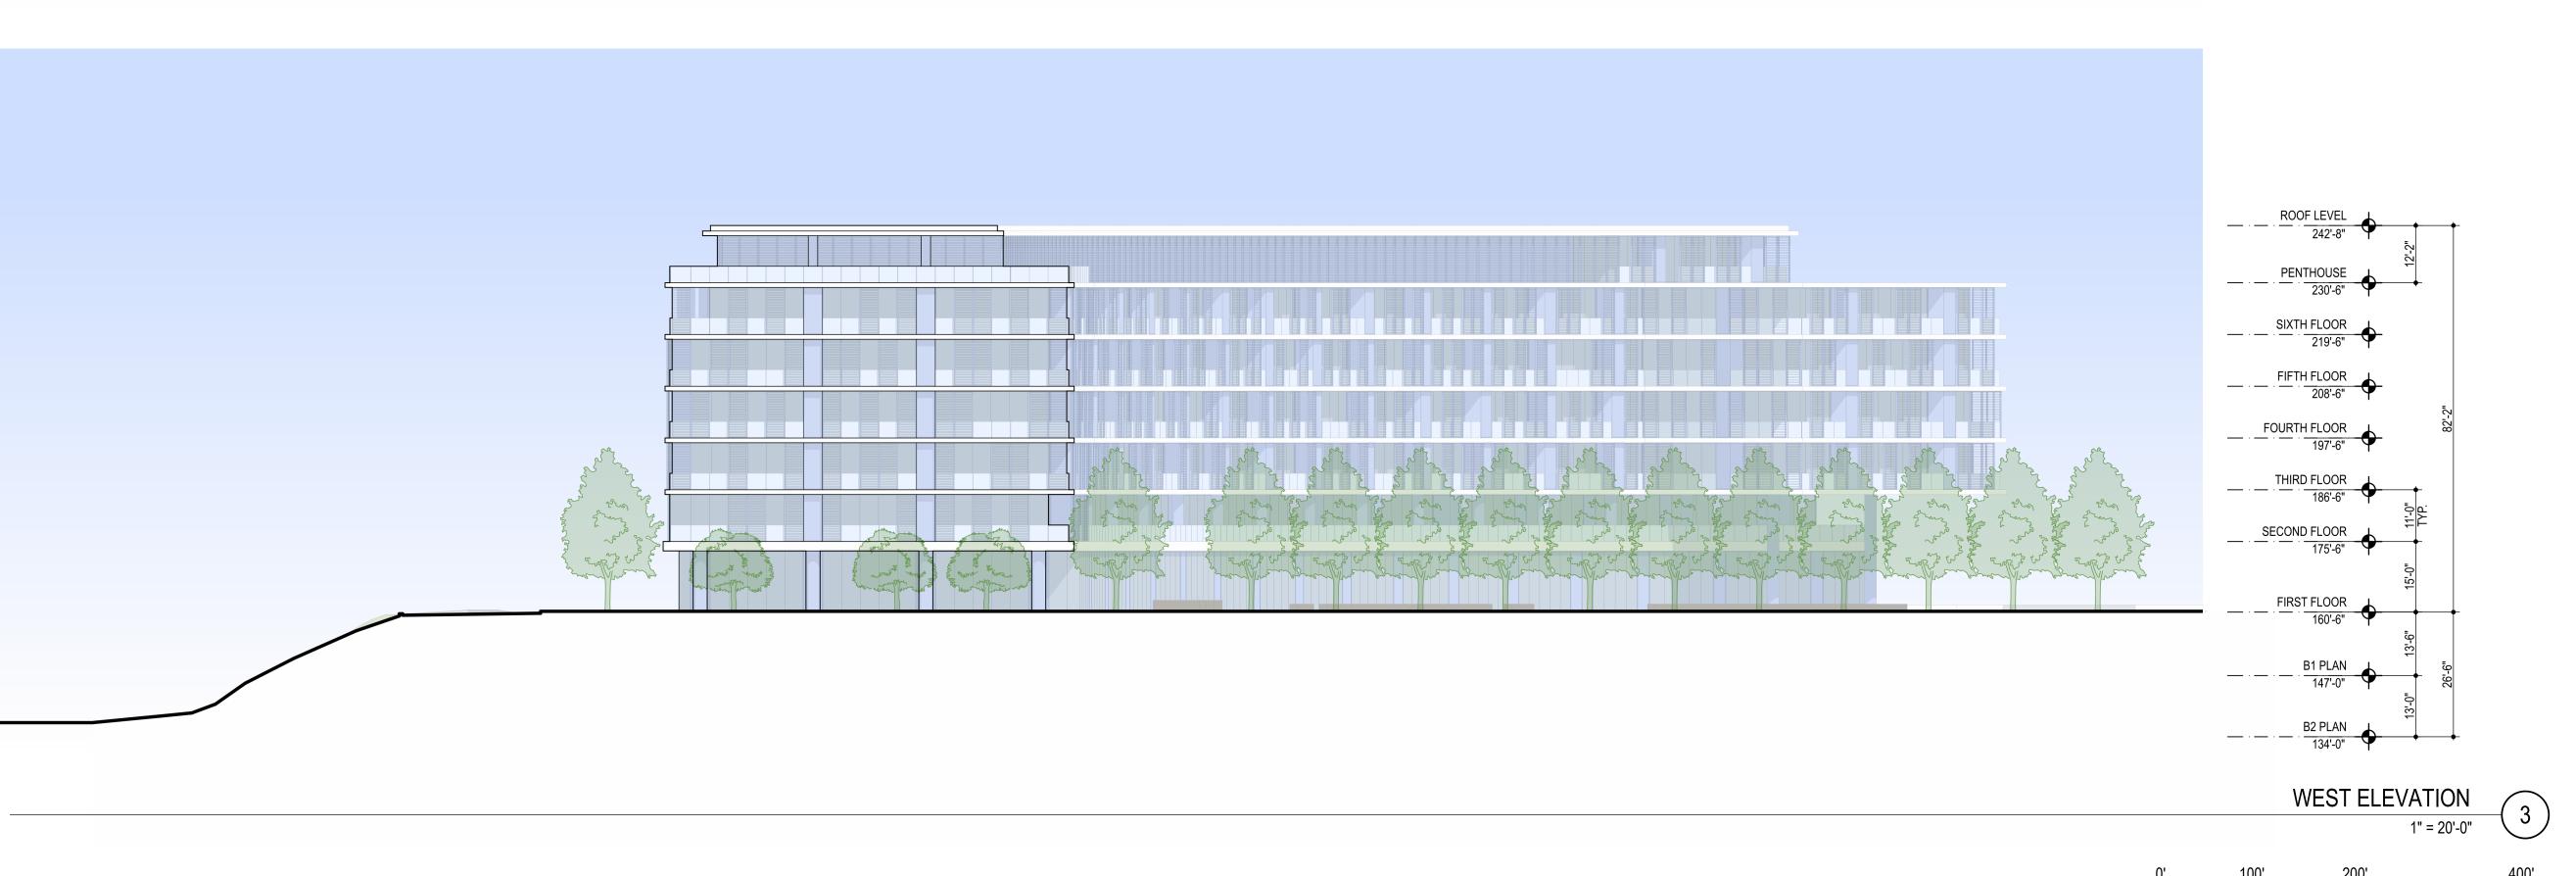
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SHEET NO.





BEACH CITIES
HEALTH DISTRICT
HEALTHY LIVING
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514 NORTH PROSPECT AVE.
REDONDO BEACH, CA 90277

PMA PROJECT NO.

19010

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BEACH CITIES
HEALTH DISTRICT
HEALTHY LIVING
CAMPUS

514 NORTH PROSPECT AVE. REDONDO BEACH, CA 90277

PMA PROJECT NO.

DRAWING TITLE NORTHEAST PERPECTIVE VIEW

DATE 02/02/2022 CHECKED PM



6310 SAN VICENTE BLVD SUITE 400 LOS ANGELES, CALIFORNIA 90048 310 358-0993

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BEACH CITIES
HEALTH DISTRICT
HEALTHY LIVING

CAMPUS

514 NORTH PROSPECT AVE. REDONDO BEACH, CA 90277


PMA PROJECT NO. 19010

DRAWING TITLE

SOUTHEAST PERPECTIVE VIEW

SCALE

NO.

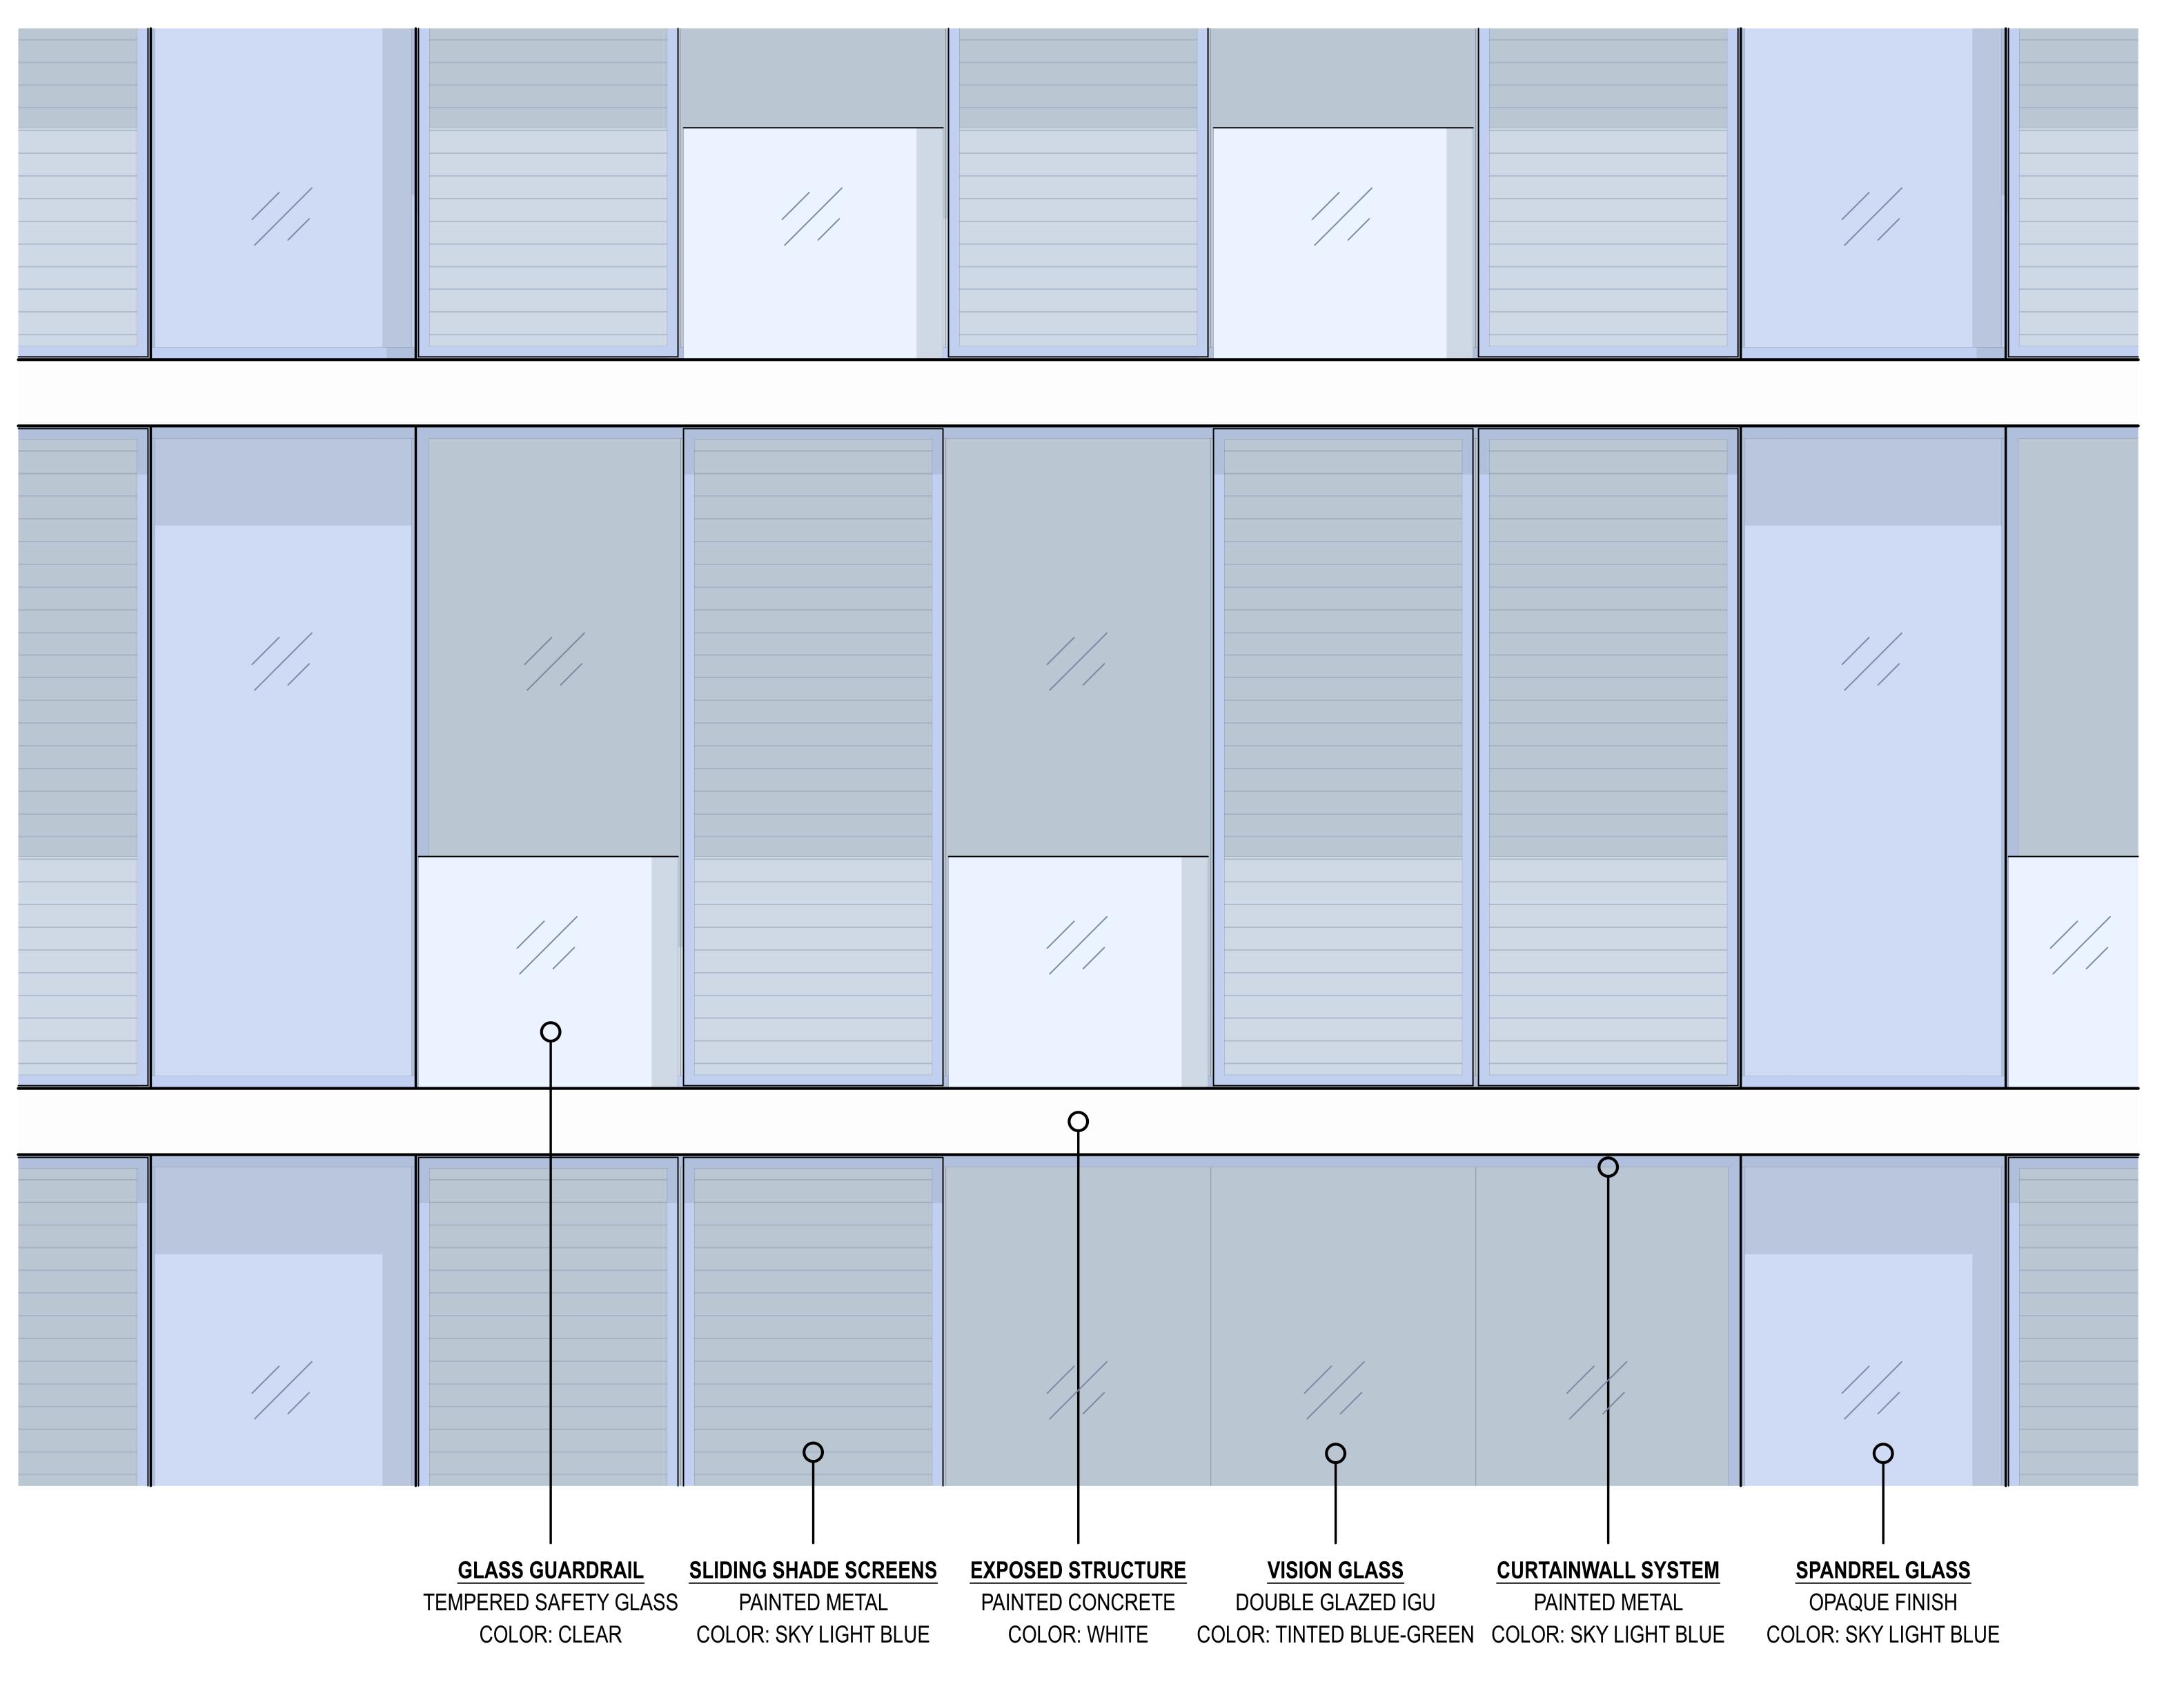

(GUARDRAIL + GLASS BEYOND)

PAUL MURDOCH ARCHITECTS

6310 SAN VICENTE BLVD SUITE 400 LOS ANGELES, CALIFORNIA 90048 310 358-0993

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BEACH CITIES
HEALTH DISTRICT
HEALTHY LIVING

514 NORTH PROSPECT AVE. REDONDO BEACH, CA 90277

CAMPUS

PMA PROJECT NO.

DRAWING TITLE

MATERIALS + COLOR PALETTE

SHEET NO.

DATE

02/02/2022

DRAWN CHECKED

EC PM

LEGEND



EXISTING TREE TO REMAIN

SHADE / SCREENING TREE

FLOWERING, ORNAMENTAL TREE



6

(13)

(13)

(13)


SHRUB AND GROUNDCOVER **PLANT MIX**



LAWN



GRASS-CRETE FIRE LANE

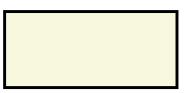

PEDESTRIAN WALKWAY



SPECIALIZED PAVING



- Large specimen trees and shrub planting
 Pergola, Water Feature, Directional Signage
 Seating areas with shade for ride share waiting
- **MAIN STREET**
 - 26' Fire Lane
 - Tree lined promenade
 - Benches shaded by tree canopies
 - Location for Farmer's Market / Health Fair Expos
- **CENTRAL LAWN**
- Natural lawn

- Group Classes such as Yoga, Zumba, Meditation - Space for community events such as outdoor movies

- Areas of trees for shade

FLEX DECK / **GROUP EXERCISE PLATFORM**

- Flexible use platform for small performances or group exercise classes

THE PORCH

- Casual, small scale dining spaces
- Adirondack / Rocking Chairs
- **GARDEN ROOF DECK**
 - Flexible event space - Outdoor dining
 - Lounge areas with fire pits
- 7 WELLNESS WALK
 - Distinct loop with distance markers and signage
 - Fitness stations, "Buddy" Benches, View areas
- SENSORY GARDENS
 - Butterfly / Habitat Garden Plantings that showcase color, texture, and smell
- COMMUNITY DEMONSTRATION GARDEN

- Vegetable boxes and citrus trees - Area for demonstration classes to gather

OUTDOOR GARDEN ROOMS

- Shaded garden rooms for small groups, surrounded by lush planting
- WALKING LABYRINTH
- **BIKE PARKING**
 - 14 Short term bike parking spaces with racks
- LANDSCAPE BUFFER
 - Trees and slope stabilization planting to frame and screen views
- PARKING LOT LANDSCAPE
 - 85 Total Parking Spaces including 6 accessible spaces
 - 1 Tree per 6 Parking Spaces
- (15) UTILITY AREA

PAUL MURDOCH ARCHITECTS

6310 SAN VICENTE BLVD SUITE 400 LOS ANGELES, CALIFORNIA 90048 310 358-0993

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BEACH CITIES HEALTH DISTRICT **HEALTHY LIVING** CAMPUS

514 NORTH PROSPECT AVE. REDONDO BEACH, CA 90277

PMA PROJECT NO.

DRAWING TITLE LANDSCAPE PLAN

1" = 50'-0" 01/26/2022 DC/CM SP/DC

L101

LANDSCAPE PLAN

SCALE: 1'' = 50'-0''



514 PROSPECT AVE. CIVIL PLANS

GENERAL

- 1. ALL NEW CONSTRUCTION SHALL COMPLY WITH THE CONTRACT DOCUMENTS AND LATEST EDITIONS OF THE CALIFORNIA BUILDING CODE, "STANDARD SPECIFICATIONS FOR PUBLIC WORKS CONSTRUCTION", AND CITY OF REDONDO BEACH LOCAL ORDINANCES AS APPLICABLE.
- ALL GRADING WORK SHALL BE PERFORMED IN ACCORDANCE WITH THE REQUIREMENTS AND RECOMMENDATIONS CONTAINED IN THE GEOTECHNICAL ENGINEERING INVESTIGATION. "GEOTECHNICAL STUDY REPORT PROPOSED SENIOR LIVING PROJECT 514 NORTH PROSPECT AVENUE, REDONDO BEACH, CALIFORNIA", BY CONVERSE CONSULANTS DATED JUNE 24, 2016.
- THE CONTRACTOR SHALL ASSUME SOLE AND COMPLETE RESPONSIBILITY FOR THE JOB SITE CONDITIONS, INCLUDING SAFETY OF ALL PERSONS AND PROPERTY, DURING THE COURSE OF CONSTRUCTION OF THIS PROJECT. THIS REQUIREMENT SHALL APPLY CONTINUOUSLY, AND SHALL NOT BE LIMITED TO NORMAL WORKING HOURS.
- PRIOR TO COMMENCING CONSTRUCTION, THE CONTRACTOR SHALL VERIFY ALL JOIN CONDITIONS FOR GRADING, DRAINAGE AND UNDERGROUND FACILITIES INCLUDING LOCATION AND ELEVATION OF EXISTING UNDERGROUND FACILITIES AT CROSSINGS WITH PROPOSED UNDERGROUND FACILITIES. IF CONDITIONS DIFFER FROM THOSE SHOWN ON THE PLANS, THE CONTRACTOR SHALL NOTIFY THE ENGINEER AND SHALL NOT BEGIN CONSTRUCTION UNTIL THE CHANGED CONDITIONS HAVE BEEN EVALUATED.
- ALL DRAWINGS ARE CONSIDERED TO BE A PART OF THE CONTRACT DOCUMENTS. THE CONTRACTOR SHALL BE RESPONSIBLE FOR THE REVIEW AND COORDINATION OF ALL DRAWINGS AND SPECIFICATIONS PRIOR TO THE START OF CONSTRUCTION. ANY DISCREPANCIES THAT OCCUR SHALL BE BROUGHT TO THE ATTENTION OF THE ARCHITECT PRIOR TO THE START OF CONSTRUCTION SO THAT A CLARIFICATION CAN BE ISSUED. ANY WORK PERFORMED IN CONFLICT WITH THE CONTRACT DOCUMENTS OR ANY CODE REQUIREMENTS SHALL BE CORRECTED BY THE CONTRACTOR AT THEIR OWN EXPENSE AND AT NO EXPENSE TO THE OWNER OR ARCHITECT.
- THE ENGINEER PREPARING THESE PLANS WILL NOT BE RESPONSIBLE FOR, OR LIABLE FOR, UNAUTHORIZED CHANGES TO OR USES OF THESE PLANS. ALL CHANGES TO THE PLANS MUST BE IN WRITING AND MUST BE APPROVED BY THE PREPARER OF THESE
- NOTES AND DETAILS ON DRAWINGS SHALL TAKE PRECEDENCE OVER GENERAL NOTES AND TYPICAL DETAILS. WHERE NO DETAILS ARE GIVEN, CONSTRUCTION SHALL BE AS SHOWN FOR SIMILAR WORK.
- THE EXISTENCE, LOCATION AND CHARACTERISTICS OF UNDERGROUND UTILITY INFORMATION SHOWN ON THESE PLANS HAVE BEEN OBTAINED FROM A REVIEW OF AVAILABLE RECORD DATA. NO REPRESENTATION IS MADE AS TO THE ACCURACY OR COMPLETENESS OF SAID UTILITY INFORMATION. THE CONTRACTOR SHALL TAKE PRECAUTIONARY MEASURES TO PROTECT THE UTILITY LINES SHOWN AND ANY OTHER LINES NOT OF RECORD OR NOT SHOWN ON THESE PLANS.
- IF AT ANY TIME DURING GRADING OPERATIONS, ANY UNFAVORABLE GEOLOGICAL CONDITIONS ARE ENCOUNTERED, GRADING IN THAT AREA WILL STOP UNTIL APPROVED CORRECTIVE MEASURES ARE OBTAINED.
- 10. THE PROPOSED GRADE IS THE FINAL GRADE AND NOT THE ROUGH GRADE. THE CONTRACTOR SHALL SUBTRACT THE THICKNESS OF THE PAVED SECTION AND/OR LANDSCAPE TOPSOIL SECTION TO ARRIVE AT THE ROUGH GRADE ELEVATION.
- 11. STRAIGHT GRADE SHALL BE MAINTAINED BETWEEN CONTOUR LINES AND SPOT ELEVATIONS UNLESS OTHERWISE SHOWN ON THE PLANS.
- 12. ALL DEBRIS AND FOREIGN MATERIAL SHALL BE REMOVED FROM THE SITE AND DISPOSED OF AT APPROVED DISPOSAL SITES. THE CONTRACTOR SHALL OBTAIN NECESSARY PERMITS FOR THE TRANSPORTATION OF MATERIAL TO AND FROM THE SITE.
- 13. ALL FILL SOILS OR SOILS DISTURBED OR OVEREXCAVATED DURING CONSTRUCTION SHALL BE COMPACTED PER THE REQUIREMENTS OF THE SOILS REPORT BUT NOT LESS THAN 90% MAXIMUM DENSITY AS DETERMINED BY A.S.T.M. SOIL COMPACTION TEST D-1557.
- 14. THE CONTRACTOR SHALL OBTAIN AN O.S.H.A. PERMIT FROM THE CALIFORNIA DIVISION OF INDUSTRIAL SAFETY PRIOR TO THE CONSTRUCTION OF TRENCHES OR EXCAVATIONS WHICH ARE FIVE FEET OR DEEPER.
- 15. DIMENSIONS TO PIPELINES ARE TO CENTERLINE UNLESS OTHERWISE NOTED.
- 16. ALL WATER LINES SHALL BE INSTALLED WITH 36" MINIMUM COVER FROM TOP OF PIPE TO FINISHED GRADE, UNLESS OTHERWISE NOTED.
- 17. THRUST BLOCKS SHALL BE INSTALLED AT WATERLINE HORIZONTAL AND VERTICAL BENDS. TEES, CAPPED ENDS AND REDUCERS ACCORDING TO THE DETAILS PROVIDED ON THESE
- 18. CONSTRUCTION STAKING FOR IMPROVEMENTS SHOWN ON THESE PLANS SHALL BE PERFORMED BY A LICENSED LAND SURVEYOR. CONSTRUCTION STAKING SURVEYOR SHALL BE RESPONSIBLE FOR COORDINATION OF THESE PLANS WITH SOURCE DRAWINGS PREPARED BY ARCHITECT, LANDSCAPE ARCHITECT, STRUCTURAL ENGINEER, MEP CONSULTANT AND ANY OTHER DISCIPLINE PRIOR TO START OF STAKING AND CONSTRUCTION. ANY DISCREPANCIES THAT OCCUR SHALL BE BROUGHT TO THE ATTENTION OF THE ARCHITECT PRIOR TO THE START OF CONSTRUCTION SO THAT A CLARIFICATION CAN BE ISSUED.
- 19. THE CONTRACTOR SHALL REPLACE ALL EXISTING IMPROVEMENTS DAMAGED DURING CONSTRUCTION TO MATCH EXISTING, INCLUDING PERMANENT TRENCH RESURFACING.
- 20. CONTRACTOR TO CONTACT UNDERGROUND SERVICE ALERT (800-227-2600) PRIOR TO EXCAVATION.
- 21. ALL DIMENSIONS ARE IN FEET OR DECIMALS THEREOF.
- 22. ALL CURB DIMENSIONS AND RADII ARE TO PAVEMENT FACE OF CURB.
- 23. CONTRACTOR TO BE AWARE OF ALL OVERHEAD LINES AT ALL TIMES, SO AS NOT TO DISTURB THEM.
- 24. WATER SHALL BE PROVIDED ONSITE AND USED TO CONTROL DUST DURING CONSTRUCTION OPERATIONS.
- 25. CONTRACTOR SHALL OBTAIN ANY NECESSARY PERMITS FROM THE CITY OF REDONDO BEACH FOR ALL WORK WITHIN THE PUBLIC RIGHT-OF-WAY.
- 26. STORM DRAINAGE SYSTEMS SHOWN ON THESE PLANS HAVE BEEN DESIGNED FOR THE FINAL SITE CONDITION AT COMPLETION OF THE PROJECT. THE CONTRACTOR IS RESPONSIBLE FOR MAINTAINING ADEQUATE DRAINAGE OF THE SITE, DURING INTERIM CONDITIONS OF CONSTRUCTION.
- 27. CONTRACTOR SHALL OBTAIN ALL REQUIRED PERMITS, INCLUDING NPDES, FROM THE APPROPRIATE JURISDICTIONAL AGENCIES FOR DISCHARGE OF GROUNDWATER THAT MAY BE NECESSARY TO ACCOMPLISH EXCAVATIONS SHOWN ON THESE PLANS.

CITY OF REDONDO BEACH GRADING NOTES

- ALL WORK SHALL BE IN ACCORDANCE WITH THE EXCAVATION AND GRADING REQUIREMENTS OF THE CITY OF REDONDO BEACH AND ANY SPECIAL REQUIREMENTS OF THE PERMIT. ANY VIOLATION WILL RESULT IN THE STOPPING OF ALL WORK UNTIL THE VIOLATION IS CORRECTED.
- NO WORK WHATSOEVER SHALL BE STARTED WITHOUT FIRST NOTIFYING THE GRADING INSPECTOR OR SOIL ENGINEER.
- 3. CUT SLOPES SHALL BE NO STEEPER THAN 2 HORIZONTAL AND 1 VERTICAL.
- FILL SLOPES SHALL BE NO STEEPER THAN 2 HORIZONTAL TO 1 VERTICAL AND SHALL HAVE NOT LESS THAN 90% COMPACTION AT THE FINISHED SURFACE, UNLESS SUPPORTED BY A SOIL STUDY PERFORMED BY A SOILS ENGINEER.
- 5. FILLS SHALL BE COMPACTED THROUGHOUT TO 90% DENSITY AS DETERMINED BY THE ASTM: D-1557-78, AND CERTIFIED BY THE SOIL ENGINEER.
- 6. CUT AND FILL SLOPES SHALL BE PLANTED WITH AN APPROVED GROUND COVER FOR EROSION CONTROL.
- 7. PLANTED SLOPES SHALL BE WATERED AND MAINTAINED.
- 8. FILL AREAS SHALL BE CLEANED OF ALL VEGETATION AND DEBRIS, SCARIFIED AND INSPECTED BY GRADING INSPECTOR OR SOIL ENGINEER AND APPROVED SOIL—TESTING AGENCY PRIOR TO PLACING OF FILL.
- 9. PRIOR TO PLACING FILLS, THE BASINS LEFT BY PULLING TREES SHALL BE INSPECTED AND APPROVED BY THE GRADING INSPECTOR OR SOIL ENGINEER.
- 10. AS FILLS ARE PLACED, SLOPE BENCHING SHALL BE PROVIDED IF NATURAL GRADE IS OVER 5 HORIZONTAL TO 1 VERTICAL. BENCHING SHALL BE A MINIMUM OF 5' WIDTH, 15' IN WIDTH AT THE TOE WITH 5' EXPOSED.
- 11. ALL EXISTING FILLS SHALL BE APPROVED BY THE GRADING INSPECTOR OR SOIL ENGINEER OR REMOVED BEFORE ANY ADDITIONAL FILLS ARE ADDED.
- 12. THE EXISTING IRRIGATION LINES AND CISTERNS SHALL BE REMOVED, OR CRUSHED IN PLACE AND BACKFILLED, AND APPROVED BY THE GRADING INSPECTOR OR SOIL ENGINEER.
- 13. APPROVED EROSION PROTECTION DEVICES SHALL BE PROVIDED AND MAINTAINED DURING THE RAINY SEASON AND SHALL BE IN THE PLACE AT THE END OF EACH DAY'S WORK.
- 14. SANITARY FACILITIES SHALL BE MAINTAINED ON THE SITE FROM BEGINNING TO COMPLETION OF GRADING OPERATIONS PER CITY OF REDONDO REGULATIONS ON CONSTRUCTION SANITATION
- 15. THE LOCATION AND PROTECTION OF ALL UTILITIES IS THE RESPONSIBILITY OF THE PERMITTEE.
- THE PERMITTEE SHALL NOTIFY THE ENGINEERING AND BUILDING SERVICES WHEN THE GRADING OPERATION IS READY FOR ROUGH GRADING INSPECTION. WHEN ALL WORK INCLUDING INSTALLATION OF ALL DRAINAGE STRUCTURES AND PROTECTIVE DEVICES HAS BEEN COMPLETED AND REQUIRED REPORTS HAVE BEEN SUBMITTED.
- 17. GRADING INSPECTION DURING INSTALLATION IS REQUIRED FOR ALL DRAIN DEVICES. FILL FERRACE BENCHES AND FILL SLOPES MUST BE APPROVED BY THE SOIL ENGINEER AND DESIGN ENGINEER PRIOR TO TERRACE PAVING.
- 18. DRAINAGE PIPE THAT WILL UNDERLAY STRUCTURES MUST BE REINFORCED CONCRETE OR CAST IRON AND THE STRUCTURE FOUNDATIONS MUST BE ENGINEERED BY A FOUNDATION ENGINEER. THE DESIGN ENGINEER SHALL BE RESPONSIBLE FOR DEPUTY INSPECTION DURING CONSTRUCTION OF THE PIPE AND WILL CERTIFY TO THE STABILITY AND THAT THE WORK WAS DONE TO HIS SATISFACTION.
- 19. SUBMISSION OF PROFESSIONAL OPINION THAT THE SUBSOILS HAVE SUFFICIENT STABILITY TO HOLD THE ADDITIONAL WEIGHT OF THE PROPOSED FILLS WITHOUT SETTLEMENT THAT WILL CAUSE DAMAGE TO PROPOSED IMPROVEMENTS MUST BE SUBMITTED MUST BE SUBMITTED TO THE BUILDING OFFICIALS PRIOR TO PLACEMENT OF FILL.
- 20. APPROVED EROSION PROTECTION DEVICES SHALL BE PROVIDED AND MAINTAINED FOR CONSTRUCTION DURING THE RAINY SEASON BETWEEN NOVEMBER 1ST AND APRIL 15TH AND SHALL BE IN PLACE AT THE END OF EACH DAY'S WORK.
- 21. ALL TRENCH BACKFILLS IN SLOPES OR LEVEL AREAS OF PRIVATE PROPERTY SHALL BE TESTED AND CERTIFIED BY THE SITE SOIL-TESTING FIRM. THE SOIL CERTIFICATION SHALL INCLUDE THE STABILITY OF THE BACKFILL AND THAT THE COMPACTION IN 90% OF THE MAXIMUM DRY DENSITY USING THE ASTM: D-1557-78.
- 22. ALL TRENCH BACKFILLS IN PUBLIC PROPERTY WHERE PRIVATE PROPERTY STRUCTURES OR SLOPES BEAR ON THEM FOR SUPPORT SHALL BE CERTIFIED BY THE SITE SOIL—TESTING FIRM.
- 23. THE ENGINEERING GEOLOGIST SHALL MAINTAIN PERIODIC INSPECTIONS AND SUBMIT A COMPLETE REPORT AND MAP UPON COMPLETION OF THE ROUGH GRADING.
- 24. ALL CUT SLOPES SHALL BE INVESTIGATED BOTH DURING AND AFTER GRADING BY AN ENGINEERING GEOLOGIST TO DETERMINE IF ANY SLOPE STABILITY PROBLEM EXISTS. SHOULD EXCAVATION DISCLOSE ANY GEOLOGICAL HAZARDS OR POTENTIAL GEOLOGIC HAZARDS, THE ENGINEERING GEOLOGIST SHALL RECOMMEND NECESSARY TREATMENT TO THE BUILDING OFFICIAL FOR APPROVAL.
- 25. WHERE SUPPORT OR BUTTRESSING OF CUT AND NATURAL SLOPE IS DETERMINED TO BE NECESSARY BY THE ENGINEERING GEOLOGIST AND SOIL ENGINEER, THE SOIL ENGINEER WILL SUBMIT DESIGN, LOCATION AND CALCULATIONS TO THE BUILDING OFFICIALS PRIOR TO CONSTRUCTIONS. THE ENGINEERING GEOLOGIST AND SOIL ENGINEER WILL INSPECT AND CONTROL THE CONSTRUCTION OF THE BUTTRESSING AND CERTIFY TO THE STABILITY OF THE SLOPE AND ADJACENT STRUCTURES UPON COMPLETION.
- 26. THE DESIGN ENGINEER SHALL EXERCISE SUFFICIENT SUPERVISORY CONTROL DURING GRADING AND CONSTRUCTION TO INSURE COMPLIANCE WITH THE APPROVED PLANS.
- 27. A GRADING PERMIT IS REQUIRED WHEN GRADING/EXCAVATION INVOLVES A CUT OR FILL DEPTH OF 3'-0" OR MORE AND/OR 200 CUBIC YARDS. SUBMIT GRADING PLANS AND SOILS REPORT TO THE BUILDING DIVISION FOR REVIEW AND APPROVAL. DUST SHALL BE CONTROLLED CONTINUOUSLY BY WATERING OR BY OTHER APPROVED MEANS IF EXCAVATION. CONTRACTOR SHALL NOTIFY THE UNDERGROUND SERVICE ALERT (USA-1-800-422-4133) PRIOR TO ANY EXCAVATION.
- 28. A SHORING PERMIT IS REQUIRED FOR ANY VERTICAL CUT OR FILL THAT IS 5'-0" IN HEIGHT OR OVER. ENGINEERED SHORING PLANS AND CALCULATION MUST BE SUBMITTED TO THE BUILDING DIVISION FOR REVIEW AND APPROVAL. PER SECTION 3301.2 OF THE CBC, THE HOLDER OF A SHORING PERMIT SHALL NOTIFY IN WRITING ALL THE OWNERS OF ADJOINING PROPERTIES NOT LESS THAN 10 DAYS BEFORE SUCH EXCAVATION IS TO COMMENCE. AN OSHA PERMIT IS ALSO REQUIRED, A COPY OF WHICH SHALL BE SUBMITTED TO THE BUILDING DIVISION. SHORING CONTRACTOR SHALL NOTIFY THE UNDERGROUND SERVICE ALERT (1-800-422-4133) PRIOR TO ANY EXCAVATION.


BEST MANAGEMENT PRACTICES FOR CONSTRUCTION ACTIVITIES

- ALL PERSONS WORKING AT THE SITE SHOULD OBTAIN, READ AND UNDERSTAND THE BEST MANAGEMENT PRACTICES PAMPHLET FOR THE TYPE(S) OF CONSTRUCTION BEING DONE.
- STOCKPILE OF SOIL, DEMOLITION DEBRIS, CEMENT, SAND, TOP SOIL, ETC. MUST BE COVERED
- WITH A WATERPROOF MATERIAL OR BERMED TO PREVENT BEING WASHED OFF SITE. 3. FUELS, OILS, PAINTS, SOLVENTS, AND OTHER LIQUID MATERIALS MUST BE KEPT INSIDE BERMED

AREAS. SPILLS MUST NOT BE WASHED TO THE STREET.

USING A WET-DRY VACUUM OR EQUIVALENT.

- 4. WASTE CONCRETE MUST NOT BE WASHED INTO STREET, STORM DRAIN CATCH BASINS, OR PUBLIC RIGHT-OF-WAY. ALL DUST AND SLURRY FROM CONCRETE CUTTING MUST BE REMOVED
- 5. TRASH AND OTHER CONSTRUCTION SOLID WASTES MUST BE PLACED IN A COVERED TRASH
- 6. ERODED SOIL FROM DISTURBED SLOPES MUST BE CONTAINED USING BERMS, SILT FENCES, SETTING BASINS, OR GOOD EROSION MANAGEMENT PRACTICES SUCH AS RESEEDING.
- WASH WATER FROM CLEANING CONSTRUCTION VEHICLES AND EQUIPMENT MUST BE KEPT ON-SITE WITHING A CONTAINMENT AREA.

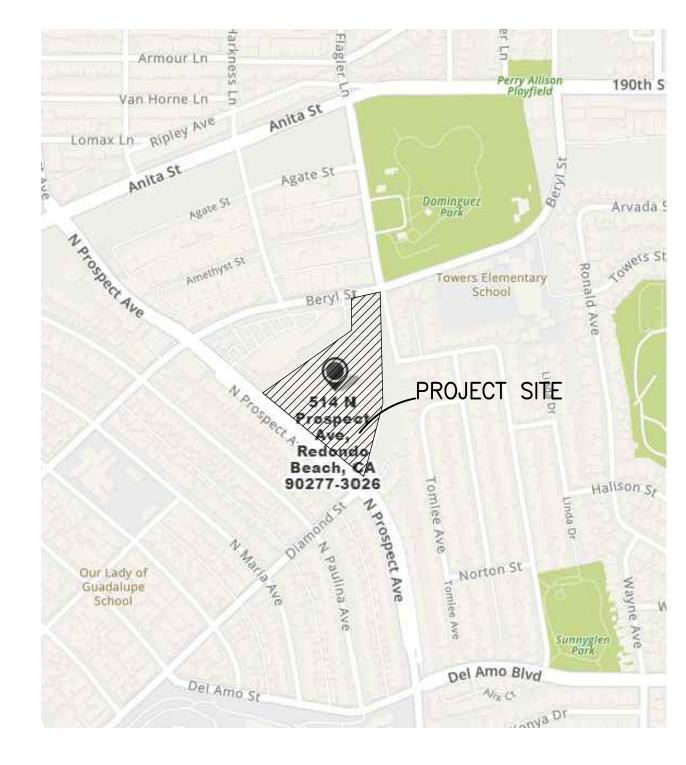

VICINITY MAP NOT TO SCALE

LEGAL DESCRIPTION

PARCEL 1

P.M.B. 144-3

APN: 7502-017-901

ABBREVIATIONS

ASPHALTIC CONCRETE

AC	ASPHALIIC CUNCRETE		
BCR	BEGIN CURVE RETURN	МН	MANHOLE
BW	BACK OF WALK	(N)	NORTH
BLDG	BUILDING	NTS	NOT TO SCALE
ВМ	BENCH MARK	PA	PLANTER AREA
BS	BOTTOM OF STAIRS	POC	POINT OF CONNECTION
BMP	BEST MANAGEMENT PRACTICES	PIV	POST INDICATOR VALVE
CB	CATCH BASIN	PCC	POINT OF COMPOUND CURVE
CI	CAST IRON	PRC	POINT OF REVERSE CURVE
CL	CENTER LINE	PRV	PRESSURE REDUCING VALVE
CMU	CONCRETE MASONRY UNIT	PVC	POLYVINYL CHLORIDE
CO	CLEANOUT	R	RADIUS
CONC	PORTLAND CEMENT CONCRETE	RCIP	RECTANGULAR CAST IRON PIPE
CF	CURB FACE	RD	ROOF DRAIN
DW	DOMESTIC WATER	RW	RIGHT-OF-WAY
(E)	EAST	(N)	SOUTH
ECR	END CURVE RETURN	S=	SLOPE EQUALS
EG	EDGE OF GUTTER	SD	STORM DRAIN
EL. OR ELEV	ELEVATION	SSMH	SANITARY SEWER MANHOLE
ELEC	ELECTRIC, ELECTRICAL	SS	SANITARY SEWER
EX. OR EXIST.	EXISTING	STD	STANDARD
FDC	FIRE DEPARTMENT CONNECTION	SDMH	STORM DRAIN MANHOLE
FF	FINISHED FLOOR	TC	TOP OF CURB
FG	FINISHED GRADE (LANDSCAPE)	TEL	TELEPHONE
FS	FINISHED SURFACE (HARDSCAPE)	TG	TOP OF GRATE
FH	FIRE HYDRANT	TOS	TOP OF STAIRS
FL	FLOW LINE	TW	TOP OF WALL
FT	FOOT OR FEET	TS	TOP OF STAIRS
FU	FIXTURE UNITS	TYP	TYPICAL
FW	FIRE WATER	TV	TELEVISION
GPM	GALLONS PER MINUTE	VIF	VERIFY IN FIELD
GV	GATE VALVE	VLT	VAULT
HDPE	HIGH DENSITY POLYETHYLENE	VCP	VITRIFIED CLAY PIPE
HP	HIGH POINT	(W)	WEST
INV.	INVERT	W	WATER
LP	LOW POINT	WM	WATER METER
MAX	MAXIMUM	WV	WATER VALVE

MINIMUM

TO BE DEMOLISHED **EROSION CONTROL**

SANDBAGS FIBER ROLL

CENTER LINE

PROPOSED BUILDING EXCAVATION OUTLINE _____ EXISTING DRAINAGE DIRECTION OF FLOW

PROTECT TREE IN PLACE

SURFACE ELEVATION/UTILITY ELEVATION

CONSTRUCTION NOTE

CURVE DATA LABEL

FLOW (DIRECTION AND GRADE)

SLOPE (DIRECTION AND RUN:RISE)

HORIZONTAL CONTROL POINT LABEL

PAD/FINISHED FLOOR ELEVATION

CURB/BACK OF CURB/GUTTER

PROPERTY LINE/RIGHT OF WAY

RETAINING WALL/SITE WALL

EXISTING SURFACE ELEVATION/UTILITY ELEVATION

LEGEND

ANNOTATION

100.00 XX

(100.00)XX

 \overline{XX}

2.0%

CX

FF=100.00

GRADE BREAK LINE RIDGE LINE LIMITS OF GRADING _____ · ____ · ____ GRADING BENCH GRADED SLOPE (HORIZONTAL:VERTICAL)

<u>UTILITY</u>

——— **SS** ——— SANITARY SEWER WATER **DOMESTIC WATER** FIRE WATER STORM DRAIN TELEPHONE ---- PERFORATED PIPE POINT OF CONNECTION COORDINATION POINT

UTILITY MANHOLE UTILITY CLEANOUT STORM DRAIN INLET AREA DRAIN/PLANTER DRAIN TRENCH DRAIN FIRE HYDRANT THRUST BLOCK

CAP OR PLUG

FIRE DEPARTMENT CONNECTION (FDC) POST INDICATOR VALVE (PIV) WATER VALVE

BACKFLOW ASSEMBLY

UTILITY METER VAULT

TITLE SHEET

UTILITY PLAN C500 FIRE ACCESS PLAN

CIVIL ENGINEER: JOHN LABIB + ASSOCIATES FRANK LAROCCA 319 MAIN STREET EL SEGUNDO, CA 90045

PAUL MURDOCH 6310 SAN VICENTE BLVD LOS ANGELES. CA 90048 TEL: 310.358.0993

GEOTECHNICAL ENGINEER: CONVERSE CONSULTANTS SIVA SIVATHASAN 717 SOUTH MYRTLE AVE MONROVIA, CA 91016 TEL: 626.930.1200



EROSION CONTROL PLAN

DEVELOPMENT/DRAINAGE PLAN 8820 Wilshire Blvd. Suite 330 Beverly Hills, California 90211

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PAUL MURDOCH ARCHITECTS



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PAUL MURDOCH

ARCHITECTS

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SCALED DIMENSIONS. CON IRACTORS SHALL VERIFY AND BE RESPONSIBLE FOR ALL DIMENSIONS AND CONDITIONS ON THE JOB AND THIS OFFICE MUST BE NOTIFIED OF ANY VARIATIONS FROM THE DIMENSIONS AND CONDITIONS SHOWN BY THESE DRAWINGS. SHOP DETAILS MUST BE SUBMITTED TO THIS OFFICE FOR REVIEW BEFORE PROCEEDING WITH FABRICATION

DRAWINGS SHALL HAVE PRECEDENCE OVER SCALED DIMENSIONS. CONTRACTORS SHALL

319 Main Street El Segundo, CA 90245 Tel: 213.239.9700 JLA Job No. 19725



DATE

BEACH CITIES HEALTH DISTRICT HEALTHY LIVING CAMPUS

514 NORTH PROSPECT AVE REDONDO BEACH, CA 90277

PMA PROJECT NO.

AS NOTED

01/06/20

DRAWN

Author

SHEET NO.

DRAWING TITLE

TITLE SHEET




IMPORTANT NOTICE SECTION 4216/4217 OF THE GOVERNMENT CODE REQUIRES A DIGALERT IDENTIFICATION NUMBER BE ISSUED BEFORE A "PERMIT TO EXCAVATE" WILL BE VALID. FOR YOUR DIGALERT I.D. NUMBER CALL UNDERGROUND SERVICE ALERT TOLL FREE 1-800-227-2600 TWO WORKING

DAYS BEFORE YOU DIG

CHECKED

Checker

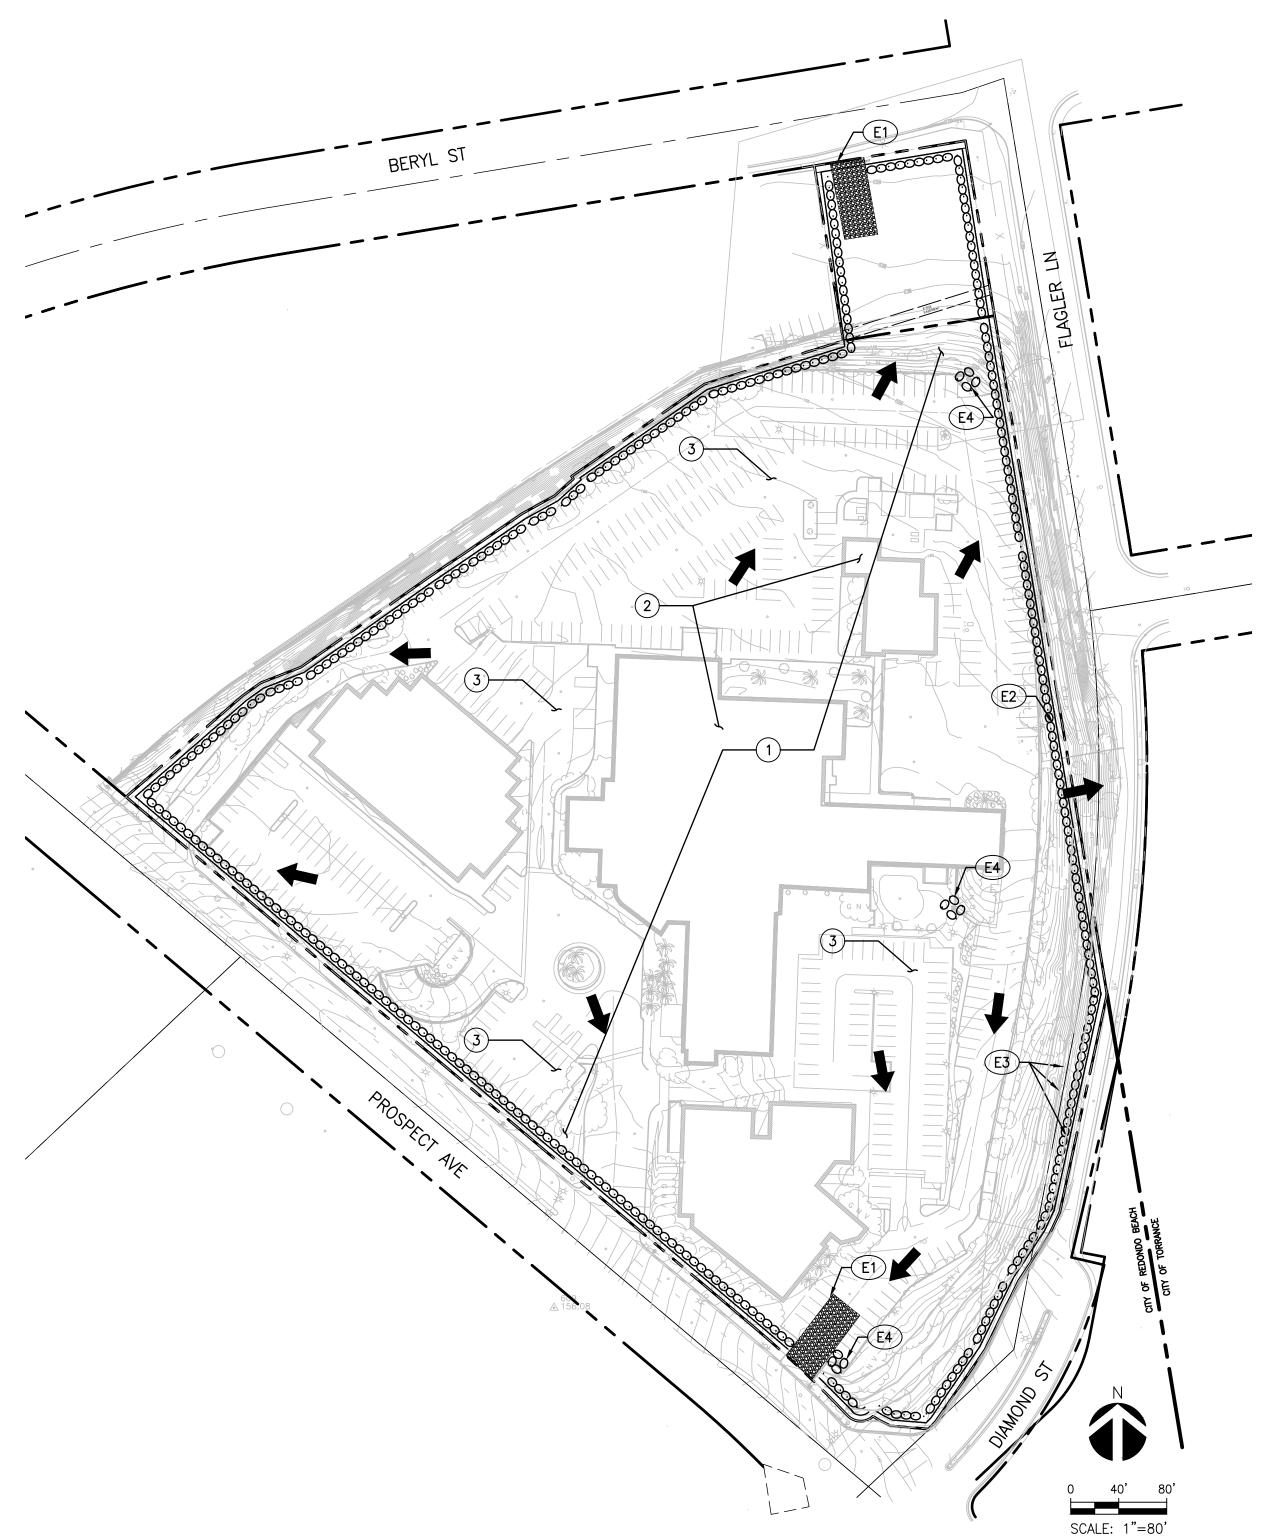

- CRUSHED AGGREGATE GREATER

LIMIT LINE OF DEMOLITION

GEOTEXTILE FILTER FABRIC

CRUSHED AGGREGRATE

 $(3^{\circ}-6^{\circ})$ DIA. STONES)

1. THE CONSTRUCTION ENTRANCE ROADWAYS SHALL BE

STABILIZED SO AS TO PREVENT SEDIMENTS FROM BEING

DEPOSITED INTO THE PUBLIC ROADS. DEPOSITIONS MUST

DOWN BY RAIN OR OTHER MEANS INTO THE STORM DRAIN

BE SWEPT UP IMMEDIATELY AND MAY NOT BE WASHED

2. STABILIZED CONSTRUCTION ENTRANCE SHALL BE LOCATED

AT ANY POINT WHERE TRAFFIC WILL BE ENTERING OR

OF WAY, STREET, ALLEY, AND SIDEWALK OR PARKING

3. IF A WASH RACK IS INCLUDED, A SEDIMENT TRAP OF

UTILIZE THE STABILIZED CONSTRUCTION ENTRANCE.

1. REMOVE ALL SEDIMENT DEPOSITED ON PAVED ROADWAYS

2. SWEEP PAVED AREAS THAT RECEIVE CONSTRUCTION TRAFFIC

LEAVING A CONSTRUCTION SITE OR FROM A PUBLIC RIGHT

SOME KIND MUST ALSO BE PROVIDED TO COLLECT WASH

4. ALL VEHICLES ACCESSING THE CONSTRUCTION SITE SHALL

12" MIN. UNLESS OTHERWISE SPECIFIED BY A SOILS ENGINEER

SYSTEM.

WATER RUNOFF.

IMMEDIATELY.

STREET MAINTENANCE NOTES

WHENEVER SEDIMENT BECOMES VISIBLE.

THAN 3" BUT SMALLER THAN 6"

GRADE

LEGEND

LIMIT LINE OF EROSION CONTROL

PROPERTY LINE OOOOOO . GRAVEL BAGS FIBER ROLL

DIRECTION OF FLOW

DEMOLITION NOTES

REMOVE & DEMOLISH (1) SEE GENERAL DEMOLITION NOTES HEREON.

(2) DEMO AND REMOVE ITEM (AS NEEDED FOR CONSTRUCTION) AS NOTED.

(3) DEMO EXISTING ASHPHALT PAVING.

EROSION CONTROL NOTES

- POSSIBLE STABILIZED CONSTRUCTION ENTRANCE LOCATIONS PER DETAIL 1, HEREON. CONTRACTOR TO LOCATE AS NECESSARY FOR CONSTRUCTION ACTIVITIES.
- (E2) PLACE SANDBAGS TRIPLE ROW PER DETAIL 2, HEREON.
- (E3) PLACE FIBER ROLL PER DETAIL 3, HEREON.
- (E4) PLACE INLET PROTECTION PER DETAIL 4, HEREON.

THE FOLLOWING BMPS AS OUTLINED IN, BUT NOT LIMITED TO, THE BEST MANAGEMENT PRACTICE HANDBOOK, CALIFORNIA STORMWATER QUALITY TASK FORCE, SACRAMENTO, CALIFORNIA, JULY 2012, MAY APPLY DURING THE CONSTRUCTION OF THIS PROJECT (ADDITIONAL MEASURES MAY BE REQUIRED IF DEEMED APPROPRIATE BY CITY INSPECTORS):

EROSION CONTROL

EC1-SCHEDULING EC2-PRESERVATION OF EXISTING VEGETATION EC3-HYDRAULIC MULCH EC4-HYDROSEEDING EC5-SOIL BINDERS EC6-STRAW MULCH

EC7-GEOTEXTILES AND MATS EC8-WOOD MULCHING EC9-EARTH DIKES AND DRAINAGE SWALES EC10-VELOCITY DISSIPATION DEVICES EC11-SLOPE DRAINS EC12-STREAMBANK STABILIZATION EC13-RESERVED

EC14-COMPOST BLANKET EC15-SOIL PREPARATION/ROUGHENING EC16-NON-VEGETATIVE STABILIZATION

TEMPORARY SEDIMENT CONTROL

SE1-SILT FENCE SE2-SEDIMENT BASIN SE3-SEDIMENT TRAP SE4-CHECK DAM SE5-FIBER ROLLS SE6-GRAVEL BAG BERM SE7-STREET SWEEPING AND VACUUMING SE8-SANDBAG BARRIER SE9-STRAW BALE BARRIER SE10-STORM DRAIN INLET PROTECTION SE11-ACTIVE TREATMENT SYSTEMS SE12-MANUFACTURED LINEAR SEDIMENT CONTROLS

EQUIPMENT TRACKING CONTROL

SE14-BIOFILTER BAGS

SE13-COMPOST SOCKS AND BERMS

TC1-STABILIZED CONSTRUCTION ENTRANCE/EXIT TC2-STABILIZED CONSTRUCTION ROADWAY TC3-ENTRANCE/OUTLET TIRE WASH

WIND EROSION CONTROL

WE1-WIND EROSION CONTROL NON-STORMWATER MANAGEMENT

NS1-WATER CONSERVATION PRACTICES NS2-DEWATERING OPERATIONS NS3-PAVING AND GRINDING OPERATIONS NS4-TEMPORARY STREAM CROSSING NS5-CLEAR WATER DIVERSION NS6-ILLICIT CONNECTION/DISCHARGE NS7-POTABLE WATER/IRRIGATION NS8-VEHICLE AND EQUIPMENT CLEANING NS9-VEHICLE AND EQUIPMENT FUELING NS10-VEHICLE AND EQUIPMENT MAINTENANCE NS11-PILE DRIVING OPERATIONS NS12-CONCRETE CURING NS13-CONCRETE FINISHING NS14-MATERIAL OVER WATER

WASTE MANAGEMENT & MATERIALS POLLUTION CONTROL

NS16-TEMPORARY BATCH PLANTS

NS15-DEMOLITION ADJACENT TO WATER

WM1-MATERIAL DELIVERY AND STORAGE WM2-MATERIAL USE WM3-STOCKPILE MANAGEMENT WM4-SPILL PREVENTION AND CONTROL WM5-SOLID WASTE MANAGEMENT WM6-HAZARDOUS WASTE MANAGEMENT WM7-CONTAMINATED SOIL MANAGEMENT WM8-CONCRETE WASTE MANAGEMENT WM9-SANITARY/SEPTIC WASTE MANAGEMENT WM10-LIQUID WASTE MANAGEMENT

GENERAL DEMOLITION NOTES

- . CONTRACTOR TO CLEAR PROJECT SITE AREA WITHIN THE CONFINES OF THE DEMOLITION LIMIT LINE. THE CONTRACTOR SHALL DEMOLISH AND REMOVE FROM THE SITE ALL EXISTING UTILITIES, STRUCTURES, PLANTERS, TREES, AND ALL OTHER SITE FEATURES, UNLESS OTHERWISE NOTED ON THE PLAN.
- 2. REMOVAL OF LANDSCAPING SHALL INCLUDE ROOTS AND ORGANIC MATERIALS.
- 3. THE CONTRACTOR SHALL BE RESPONSIBLE FOR OBTAINING ANY AND ALL PERMITS AND SHALL PAY ALL FEES NECESSARY FOR ENCROACHMENT, GRADING, DEMOLITION AND DISPOSAL OF SAID MATERIALS AS REQUIRED BY PRIVATE, LOCAL AND STATE
- 4. THE CONTRACTOR SHALL BE RESPONSIBLE FOR A SITE INSPECTION TO FULLY ACKNOWLEDGE THE EXTENT OF THE DEMOLITION WORK.
- 5. THE CONTRACTOR SHALL VERIFY AND LOCATE ALL EXISTING ABOVE AND UNDERGROUND UTILITIES. LOCATIONS SHOWN ON THE PLANS ARE APPROXIMATE AND ARE SHOWN FOR GENERAL INFORMATION ONLY.
- 6. DAMAGE TO ANY EXISTING UTILITIES AND SERVICES TO REMAIN SHALL BE THE RESPONSIBILITY OF THE CONTRACTOR. CONTRACTOR SHALL REPAIR AND/OR REPLACE IN KIND.
- 7. EROSION CONTROL MEASURES SHALL BE IMPLEMENTED TO PREVENT DEBRIS AND UNSUITABLE MATERIALS FROM ENTERING STORM DRAINS, SANITARY SEWERS AND STREETS.
- 8. DUST CONTROL SHALL BE IMPLEMENTED DURING DEMOLITION.
- 9. DEMOLITION IS LIMITED TO WITHIN DEMOLITION LIMIT LINE UNLESS NOTED OTHERWISE.
- 10. THE CONTRACTOR SHALL VERIFY THE LOCATION AND QUANTITY OF EXISTING SURFACE STRUCTURES AND SHALL BE SOLELY RESPONSIBLE FOR ANY UNIDENTIFIED UTILITIES, IMPROVEMENTS, TREES, ETC. TO BE DEMOLISHED AND REMOVED WITHIN THE DEMOLITION LIMIT LINE, INCLUDING APPURTENANT FOUNDATIONS OR SUPPORTS.
- 11. DEMOLITION CALLOUTS IN THIS SECTION ARE REPRESENTATIVE OF WHAT IS TO BE DONE, NOT AN ITEMIZED ACCOUNTING FOR EACH PIPE, CATCH BASIN, MANHOLE, VAULT, ETC. THAT IS TO BE DEMOLISHED, REMOVED AND DISPOSED OF.

EROSION CONTROL NOTES

- 1. TEMPORARY EROSION CONTROL DEVICES SHOWN ON THE GRADING PLAN WHICH INTERFERE WITH THE WORK SHALL BE RELOCATED OR MODIFIED AS AND WHEN THE INSPECTOR SO DIRECTS AS THE WORK PROGRESSES TO MEET "AS GRADED" CONDITIONS.
- 2. ALL LOOSE SOIL AND DEBRIS SHALL BE REMOVED FROM THE STREET AREAS UPON STARTING OPERATIONS AND PERIODICALLY THEREAFTER AS DIRECTED BY THE INSPECTOR
- 3. WHEN THE INSPECTOR SO DIRECTS, A 12-INCH BERM SHALL BE MAINTAINED ALONG THE TOP OF THE SLOPE OF THOSE FILLS ON WHICH GRADING IS NOT IN PROGRESS.
- 4. STORM AND SEWER DRAIN TRENCHES THAT ARE CUT THROUGH BASIN DIKES OR BASIN INLET DIKES SHALL BE PLUGGED WITH SANDBAGS.
- 5. EXCEPT WHEN THE INSPECTOR DIRECTS OTHERWISE, ALL DEVICES SHOWN SHALL BE IN PLACE AT THE END OF EACH WORKING DAY WHEN RAIN IS FORECAST, AND SHALL BE MAINTAINED DURING THE RAINY SEASON (OCTOBER 15 TO APRIL 15).
- 6. SANDBAGS SHALL BE STOCKPILED ON SITE, READY TO BE PLACED IN POSITION WHEN RAIN IS FORECAST, OR WHEN THE INSPECTOR SO DIRECTS.
- 7. A "STANDBY EMERGENCY CREW" SHALL BE ALERTED BY THE PERMITTEE OR THE CONTRACTOR TO PERFORM EMERGENCY WORK DURING RAINSTORMS. THE PARTY TO BE CONTACTED IS: _____ (TO BE FILLED IN BY CONTRACTOR)

PHONE NUMBER:

- FIBER ROLL

INSTALL FIBER ROLL ALONG A

TO WATER MOVEMENT.

LEVEL CONTOUR, PERPENDICULAR

DUST CONTROL NOTES


- 1. DUST SHALL BE CONTROLLED BY WATERING AND/OR APPLYING A DUST PALLIATIVE. THE DUST PALLIATIVE SHALL BE APPLIED IN THE AMOUNT AT THE LOCATIONS AS DIRECTED BY THE ENGINEER.
- 2. WATER FOR DUST CONTROL SHALL BE APPLIED BY MEANS OF PRESSURE TYPE DISTRIBUTORS OR PIPE LINES EQUIPPED WITH A SPRAY SYSTEM OR HOSES WITH NOZZLES THAT WILL INSURE A UNIFORM APPLICATION OF WATER.
- 3. UNLESS WATER IS APPLIED BY MEANS OF PIPE LINES, AT LEAST ONE MOBILE UNIT WITH A MINIMUM CAPACITY OF 100 GALLONS SHALL BE AVAILABLE FOR APPLYING WATER.
- 4. ALL SOIL MATERIALS OR DEBRIS TRUCKED FROM THE SITE SHALL BE COVERED AND SPRINKLED PRIOR TO ENTERING PUBLIC
- 5. PROVIDE FOR WET SUPPRESSION OR CHEMICAL STABILIZING OF EXPOSED SOILS.
- 6. PROVIDE FOR RAPID CLEAN-UP OF SEDIMENTS DEPOSITED ON THE PAVED ROADS.
- 7. LIMIT THE AMOUNT OF AREAS DISTURBED BY CLEARING & EARTH MOVING OPERATIONS BY SCHEDULING THESE ACTIVITIES IN PHASES.




FILTERED WATER - 2 BAGS HIGH AND STAGGERED ROWS OF GRAVEL BAGS (12" MINIMUM WIDTH & 12" MINIMUM DROP INLET W/ GRATE. SIZED PER PLAN GRAVEL OVER ENTIRE WIRE MESH WITH FILTER FABRIC

- 1. PLACE WIRE MESH OVER AND 1' (MINIMUM) BEYOND THE INLET STRUCTURE. (MESH OPENINGS NOT TO EXCEED 1" x 1" WIRE)
- 2. PLACE FILTER FABRIC OVER WIRE MESH.
- 3. PLACE 3" TO 3" GRAVEL OVER THE WIRE MESH WITH FILTER FABRIC (12" MINIMUM DEPTH
- DESIGNATION D4355.
- 5. BAG SIZE: EACH GRAVEL-FILLED BAG SHOULD HAVE A LENGTH OF 18 IN., WIDTH OF 12 IN., THICKNESS OF 3 IN., AND MASS OF APPROXIMATELY 33 LBS. BAG DIMENSIONS ARE NOMINAL, AND MAY VARY BASED ON LOCALLY AVAILABLE MATERIALS.
- 6. FILL MATERIAL: FILL MATERIAL SHALL BE 0.5 TO 1.0 INCH CRUSHED ROCK, CLEAN AND FREE OF CLAY, ORGANIC MATTER, AND OTHER DELETERIOUS MATERIAL, OR OTHER SUITABLE OPEN-GRADED, NON-COHESIVE, POROUS GRAVEL.



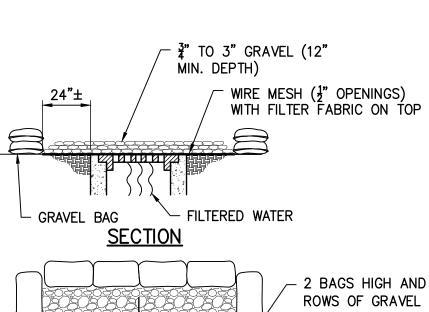

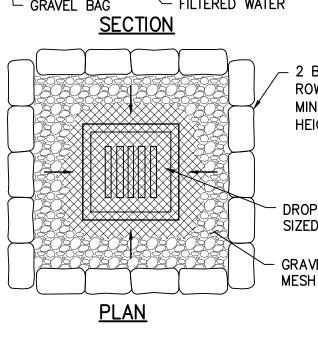

- OVER THE ENTIRE INLET OPENING).
- 4. BAG MATERIAL: BAGS SHOULD BE WOVEN POLYPROPYLENE, POLYETHYLENE OR POLYAMIDE FABRIC, MINIMUM UNIT WEIGHT OF 4 OUNCES/YD2, MULLEN BURST STRENGTH EXCEEDING 300 LB/IN2 IN CONFORMANCE WITH THE REQUIREMENTS IN ASTM DESIGNATION D3786, AND ULTRAVIOLET STABILITY EXCEEDING 70% IN CONFORMANCE WITH THE REQUIREMENTS IN ASTM
- 7. USE PYRAMID APPROACH WHEN STACKING BAGS.
- 8. LEAVE GAP OF ONE BAG ON TOP ROW TO SERVE AS SPILLWAY.







PAUL MURDOCH ARCHITECTS

8820 Wilshire Blvd. Suite 330

Beverly Hills, California 90211

310 358-0993 F.310 358-9196

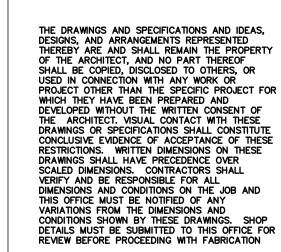

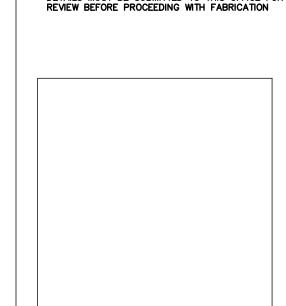



Tel: 213.239.9700

JLA Job No. 19725



SIGN DATE 01/28/2022

BEACH CITIES HEALTH DISTRICT **HEALTHY LIVING** CAMPUS

DATE

514 NORTH PROSPECT AVE REDONDO BEACH, CA 90277

PMA PROJECT NO.

DRAWING TITLE


EROSION CONTROL PLAN

AS NOTED

01/06/20 DRAWN CHECKED Author Checker

C100

SHEET NO.

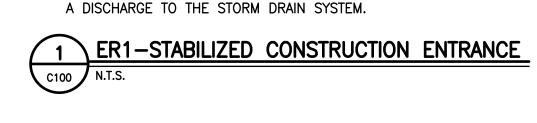

3. PAVEMENT WASHING WITH WATER IS PROHIBITED IF IT RESULTS IN

NOTES:


CONFORMANCE WITH THE REQUIREMENTS IN ASTM DESIGNATION D3786. AND ULTRAVIOLET STABILITY EXCEEDING 70% IN CONFORMANCE WITH THE REQUIREMENTS IN ASTM DESIGNATION

ROCK, CLEAN AND FREE OF CLAY, ORGANIC MATTER, AND OTHER DELETERIOUS MATERIAL, OR OTHER SUITABLE OPEN-GRADED,

4. TURN THE ENDS OF GRAVEL BAG BARRIER UP SLOPE TO PREVENT RUNOFF FROM GOING AROUND BARRIER.

5. USE PYRAMID APPROACH WHEN STACKING BAGS.


2 ER2-GRAVEL BAG BARRIER

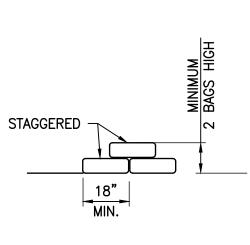

1. BAG MATERIAL: BAGS SHOULD BE WOVEN POLYPROPYLENE, POLYETHYLENE OR POLYAMIDE FABRIC, MINIMUM UNIT WEIGHT OF 4 OUNCES/YD2. MULLEN BURST STRENGTH EXCEEDING 300 LB/IN2 IN

2. BAG SIZE: EACH GRAVEL-FILLED BAG SHOULD HAVE A LENGTH OF 18 IN., WIDTH OF 12 IN., THICKNESS OF 3 IN., AND MASS OF APPROXIMATELY 33 LBS. BAG DIMENSIONS ARE NOMINAL, AND MAY VARY BASED ON LOCALLY AVAILABLE MATERIALS.

3. FILL MATERIAL: FILL MATERIAL SHALL BE 0.5 TO 1.0 INCH CRUSHED NON-COHESIVE. POROUS GRAVEL.

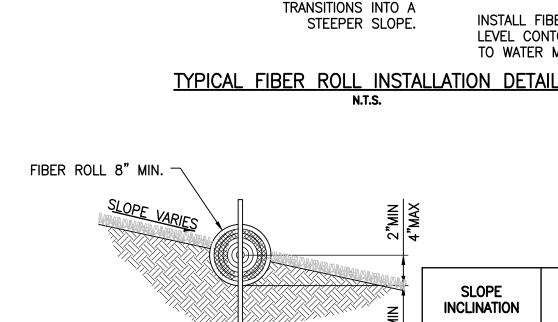


MAXIMUM SHEET FLOW LENGTH INCLINATION (FOR SLOPE INTERRUPTION) ¾"X¾" WOOD STAKES. < 4:1 (H:V) MAX 4' SPACING. 4:1-2:1 (H:V) ENTRENCHMENT DETAIL > 2:1 (H:V)

INSTALL FIBER ROLL

NEAR SLOPE WHERE I

3 ER3-FIBER ROLL

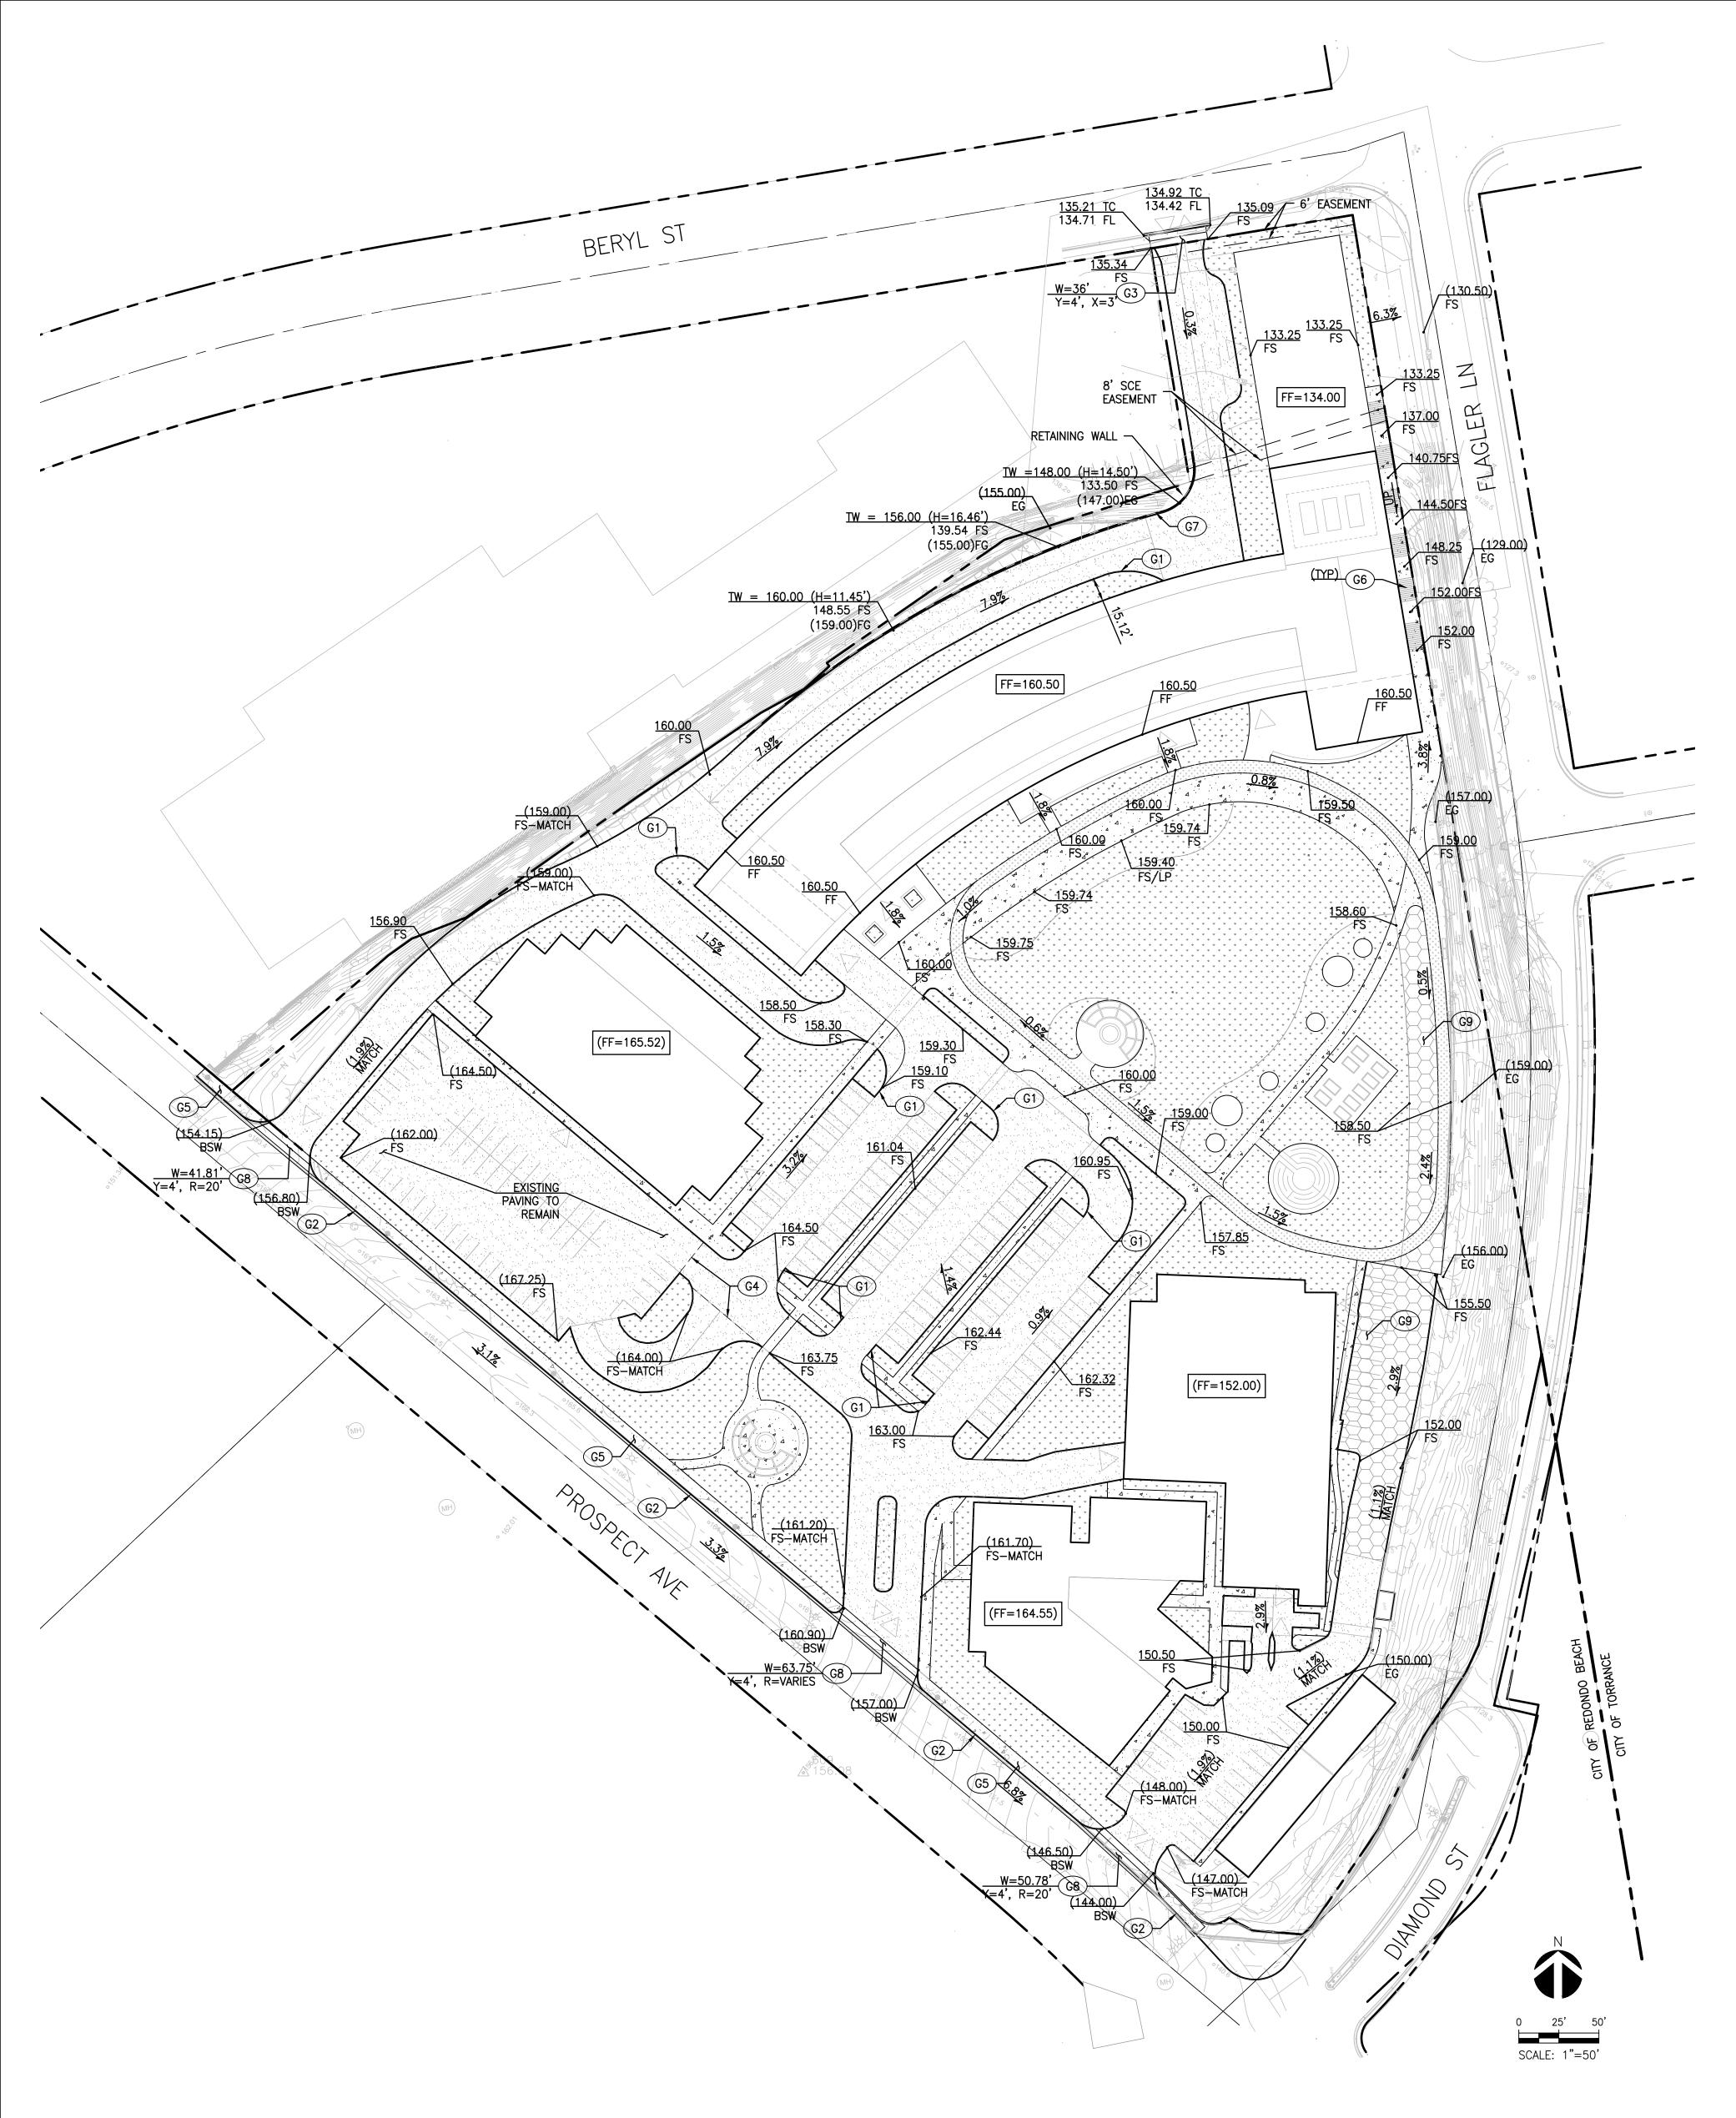

LANDSCAPE BY OTHERS. CONCRETE PAVING.


ASPHALT PAVING. DEPTH OF ASPHALT AND BASE TO MATCH EXISTING.

COMPACTED DG PER LANDSCAPE PLANS. GRASSCRETE.

CONSTRUCTION NOTES


- (G1) INSTALL 6" CONCRETE CURB PER DETAIL 1, HEREON.
- (G2) INSTALL CURB AND GUTTER PER APWA STD PLAN 120-1.
- (G3) INSTALL DRIVEWAY APRON PER APWA STD PLAN 110-2, TYPE B.
- (G4) SAWCUT TO LIMIT AS SHOWN.
- (G5) INSTALL SIDEWALK PAVING PER DETAIL 3, HEREON.
- (G6) STAIRS ON GRADE PER DETAIL 5, HEREON.
- (G7) INSTALL RETAINING WALL BY OTHERS.
- (G8) INSTALL DRIVEWAY APRON PER APWA STD PLAN 110-2, TYPE C.

1. ALL PAVING AND PAVERS SHALL BE INSTALLED PER RECOMMENDATIONS STATED IN THE PROJECT GEOTECHNICAL REPORT.

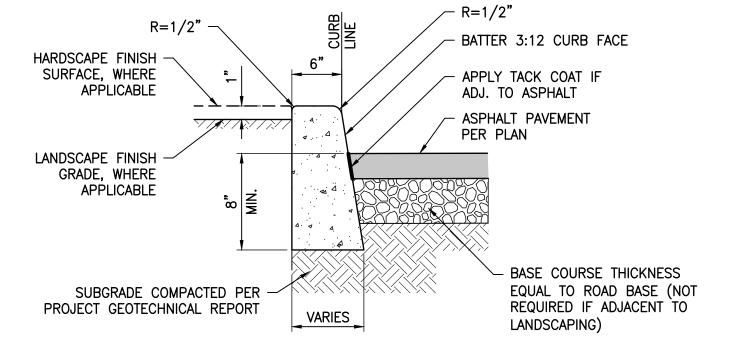


- 1. ISOLATION JOINTS SHALL BE PLACED ONLY AS SPECIFIED.
- 2. CONTROL JOINTS CONSISTING OF 1" DEEP SCORES SHALL BE PLACED AT 10' INTERVALS O.C.
- 3. WHERE A WALK IS ADJACENT TO THE CURB, THE JOINTS SHALL ALIGN WITH JOINTS IN

1 CONCRETE CURB DETAIL C210 N.T.S.

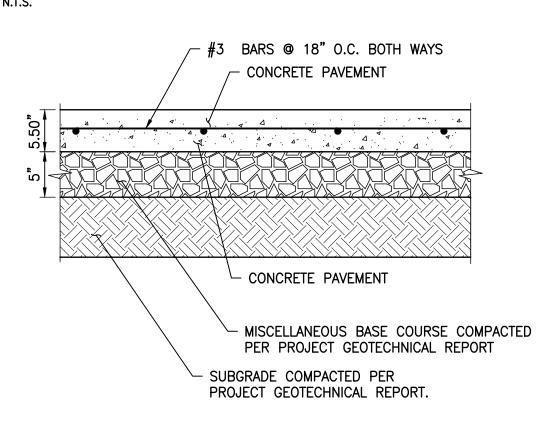

NOTES:

- 1. ALL TREAD SURFACES SHALL BE SLIP-RESISTANT.
- 2. REFER TO ARCHITECTURAL DRAWINGS FOR COLOR, PATTERN, TEXTURE, AND FINISH.
- 3. SEE PLAN FOR LOCATION OF CONTROL JOINTS.
- 4. CONCRETE STRENGTH f'c = 3500 PSI MIN.

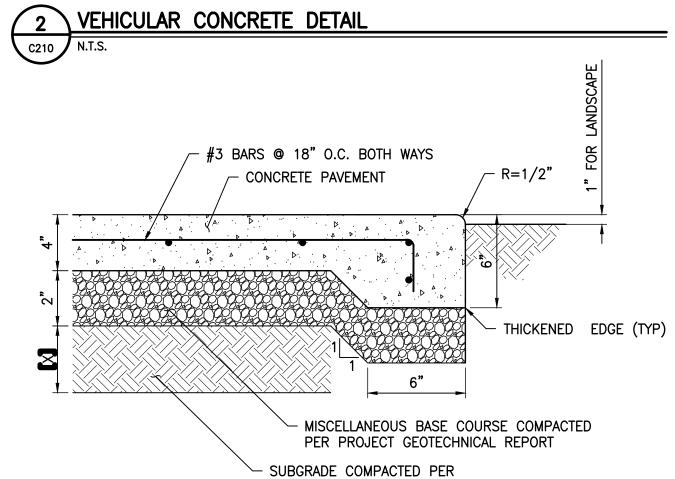

NOTES:

- 1. ALL TREAD SURFACES SHALL BE SLIP-RESISTANT.
- 2. REFER TO ARCHITECTURAL DRAWINGS FOR COLOR, PATTERN, TEXTURE, AND FINISH.

PROJECT GEOTECHNICAL REPORT.

3. SEE PLAN FOR LOCATION OF CONTROL JOINTS.

3 CONCRETE WALK SECTION

ESTIMATED EARTHWORK QUANTITIES

REMOVAL AND RECOMPACTION: O CUBIC YARDS 7,810 CUBIC YARDS 16,760 CUBIC YARDS (FROM EXISTING HOSPITAL BASEMENT)


8.950 CUBIC YARDS NET (FILL/IMPORT):

REPLACEMENT.

EARTHWORK CALCULATION NOTES:

1. ESTIMATED EARTHWORK ABOVE IS BASED ON DESIGN FINISH GRADES TO EXISTING GRADES AND/OR CONTOURS AS PROVIDED ON THE BASE SURVEY. THE ESTIMATED EARTHWORK DOES NOT ACCOUNT FOR THE THICKNESS OF PAVEMENTS, FOUNDATIONS AND SLABS ON GRADE, FOOTINGS, AND CONSTRUCTION MEANS AND METHODS.

- 2. THE ESTIMATED EARTHWORK QUANTITIES DO NOT INCLUDE SHRINKAGE AND/OR EXPANSION FACTORS DUE TO COMPACTION OR OVER EXCAVATION QUANTITIES.
- 3. ESTIMATED EARTHWORK QUANTITIES ABOVE ASSUME THAT ALL ONSITE MATERIALS ARE SUITABLE FOR BACKFILLING. HOWEVER, ACTUAL EXISTING ONSITE MATERIALS AND IMPORTED MATERIALS MUST FIRST BE APPROVED BY THE GEOTECHNICAL ENGINEER PRIOR TO INSTALLATION, REMOVAL,
- 4. REMEDIAL GRADING INCLUDES OVEREXCAVATION OF 3' VERTICAL AND 5' HORIZONTAL EXCAVATIONS BELOW ANY PROPOSED FOUNDATION.

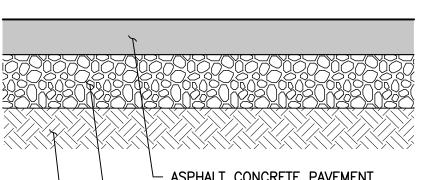

ASPHALT CONCRETE PAVEMENT - 90% COMPACTED CRUSHED AGGREGATE OR MISCELLANEOUS BASE COURSE


└ 95% RECOMPACTED SUBGRADE


A.C. PAVEMENT TYPE	ASPHALT CONCRETE (INCHES)	BASE COURSE (INCHES)
VEHICULAR PARKING	2.5"	3.5"
HEAVY TRUCK TRAFFIC	6"	5.5"


. PAVEMENT SECTIONS ARE BASED ON RECOMMENDATIONS


FROM THE PROJECT GEOTECHNICAL REPORT. 2. SUBGRADE PREPARATION SHALL BE PERFMOED PER THE RECOMMENDATIONS IN THE PROJECT GEOTECHNICAL REPORT

4 ASPHALT PAVING DETAIL

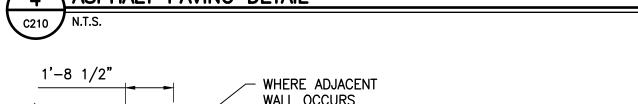

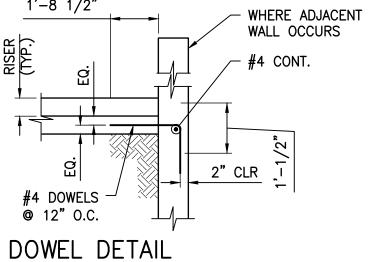

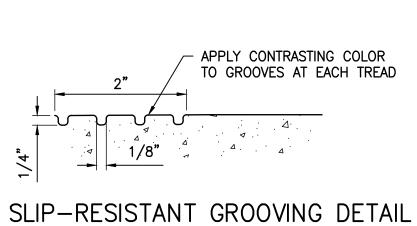

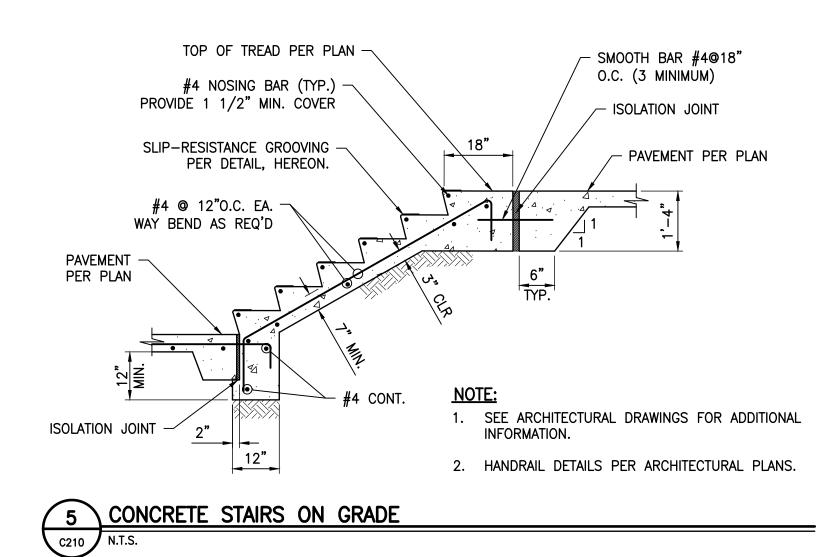



PAUL MURDOCH

ARCHITECTS

8820 Wilshire Blvd. Suite 330 Beverly Hills, California 90211

310 358-0993 F.310 358-9196

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Labib Funk + Associates Burnett + Young Structural | Civil Engineers Shoring Engineers

SIGN DATE 01/28/2022

319 Main Street

Tel: 213.239.9700

JLA Job No. 19725

El Segundo, CA 90245

BEACH CITIES HEALTH DISTRICT HEALTHY LIVING CAMPUS

514 NORTH PROSPECT AVE

REDONDO BEACH, CA 90277

PMA PROJECT NO.


DRAWING TITLE

GRADING PLAN

AS NOTED

01/06/20 Author Checker

C210

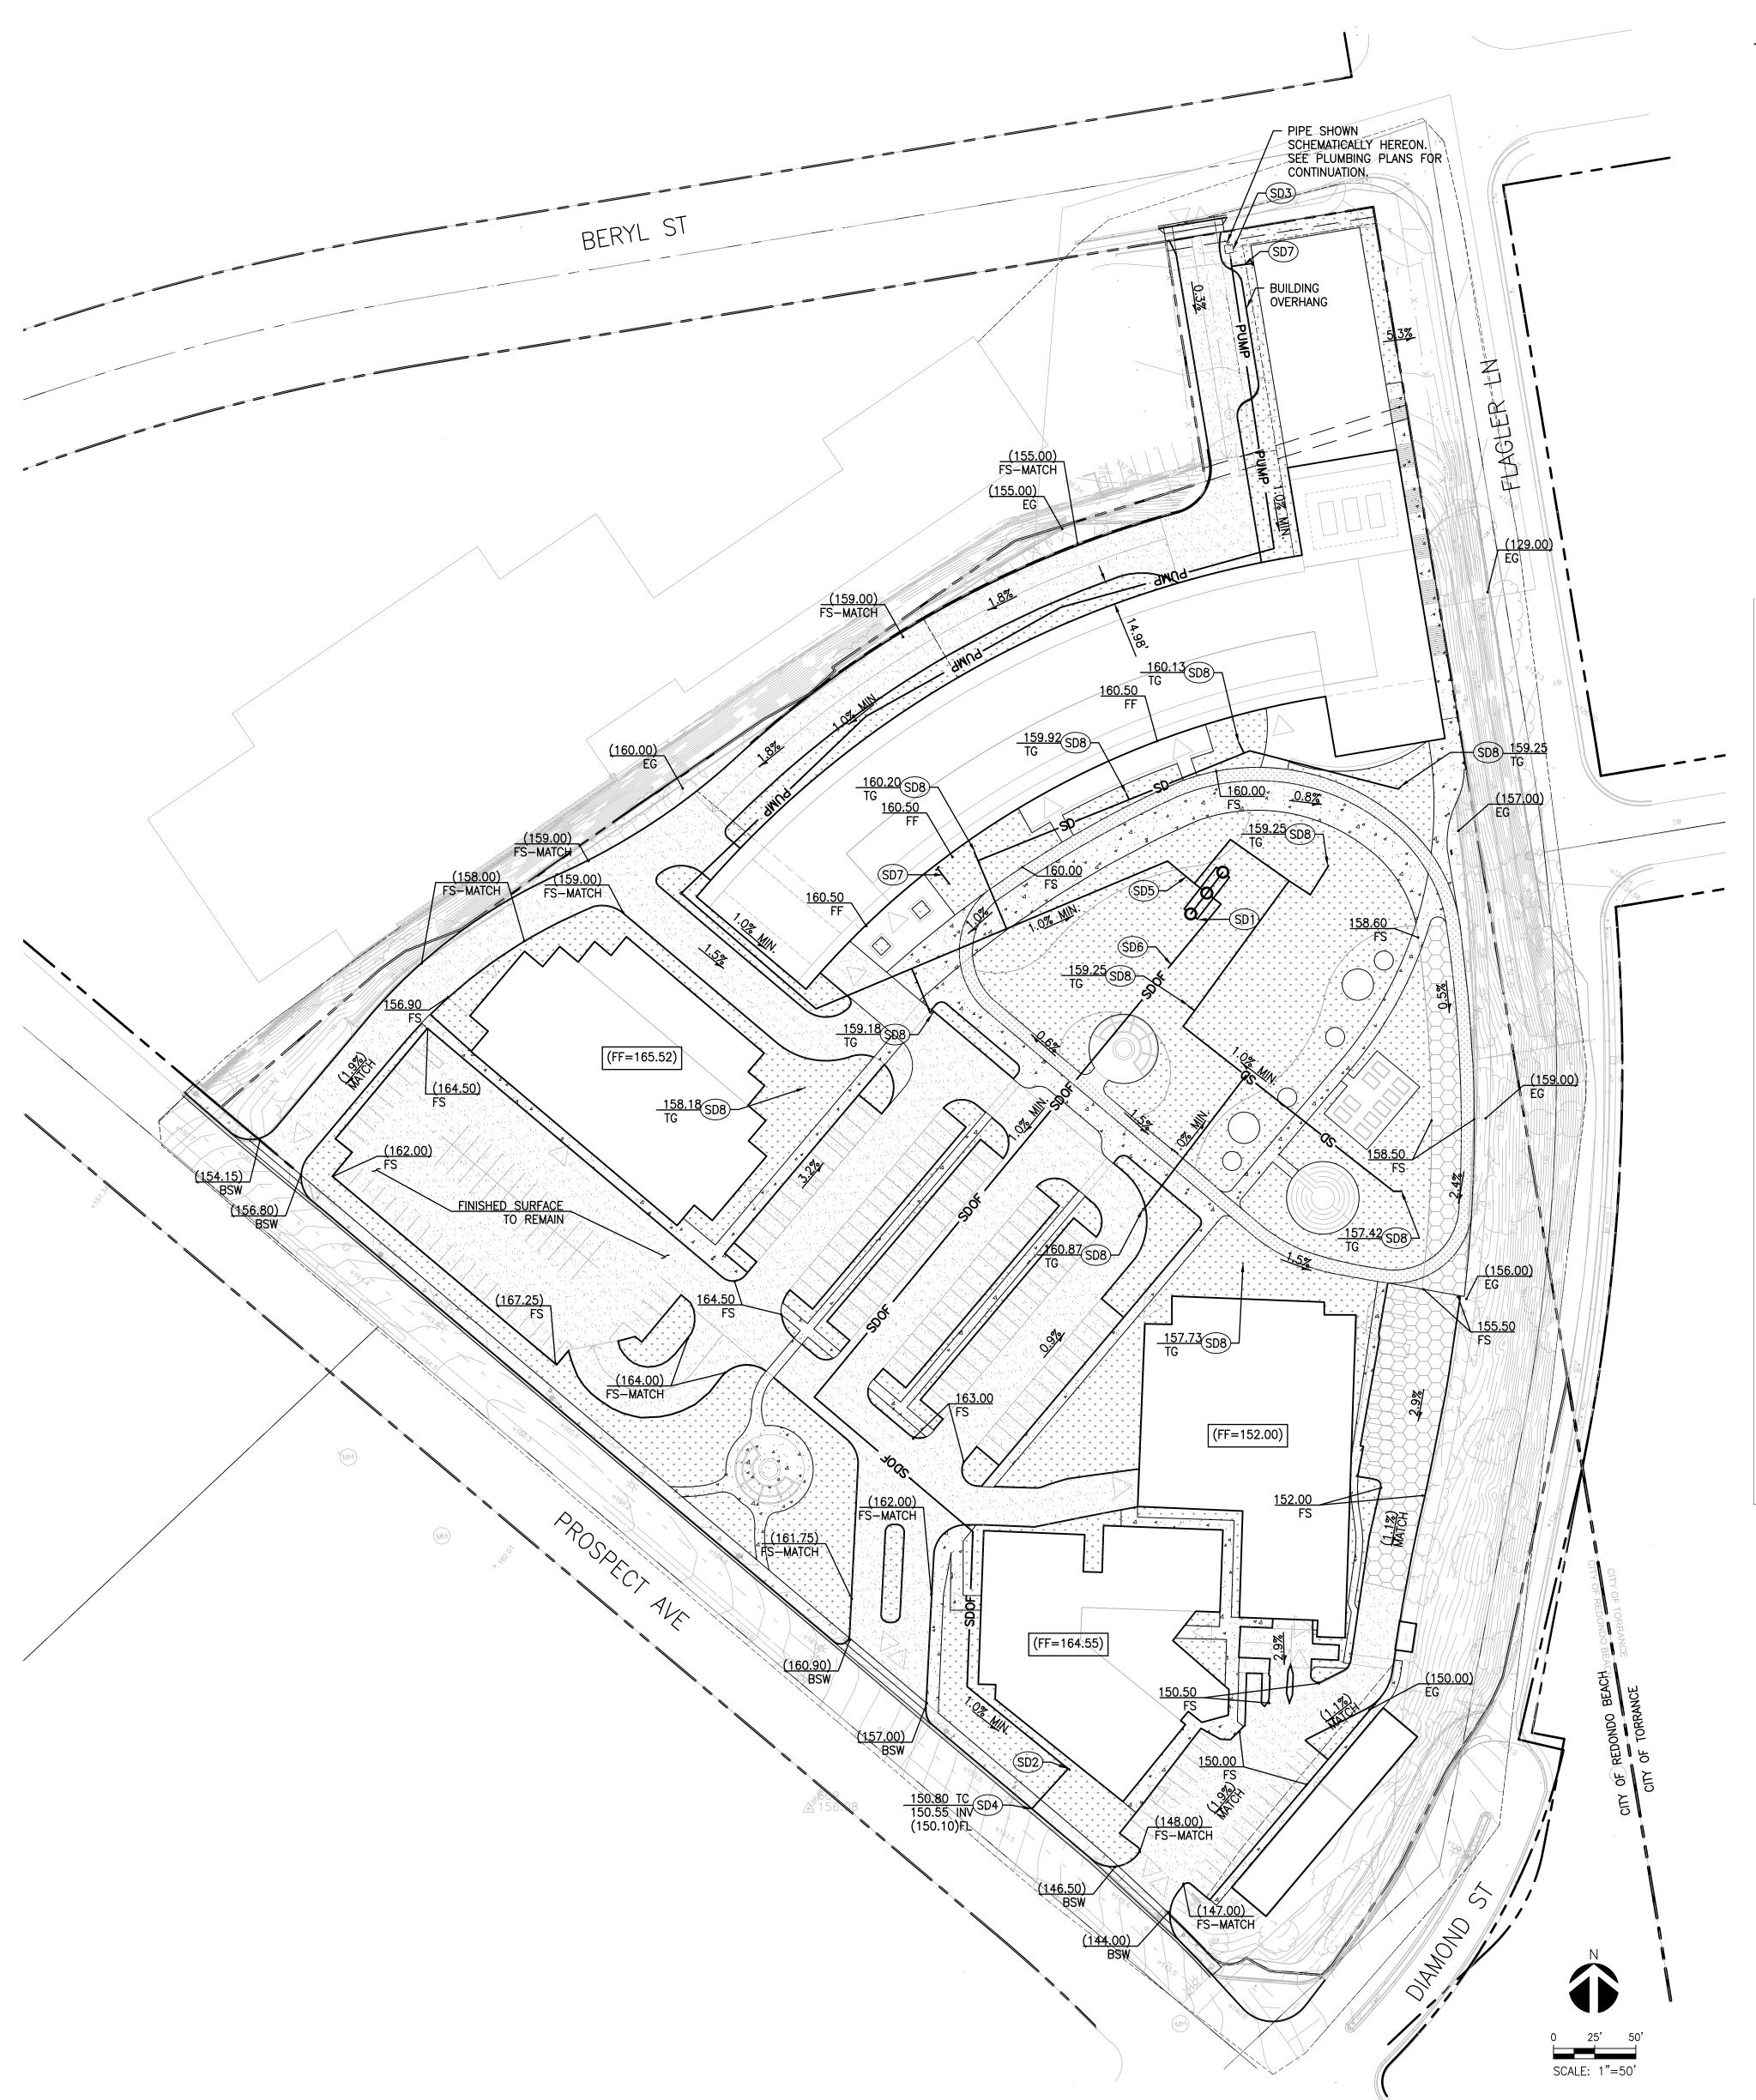

LEGEND

LANDSCAPE BY OTHERS.

CONCRETE PAVING. ASPHALT PAVING. DEPTH OF ASPHALT AND BASE TO MATCH EXISTING.

COMPACTED DG PER LANDSCAPE PLANS. GRASSCRETE.

PROJECT SITE CHARACTERISTICS QUANTITIES 433,194 TOTAL SITE AREA (S.F.) 46,807 PROPOSED BUILDING FOOTPRINT(S.F) 57,336 EXISTING BUILDING FOOTPRINT(S.F) 183,954 PROPOSED HARDSCAPE(S.F) 27,947 EXISTING HARDSCAPE TO REMAIN(S.F) 72% IMPERVIOUS % LANDSCAPE 109,097 11,053 GRASSCRETE 120,150 TOTAL PERVIOUS AREA (S.F.) RAINFALL INTENSTITY (IN/HR) 0.75

8,696

CONSTRUCTION NOTES

STORM DRAIN

(SD1) INSTALL DRYWELL PER DETAIL 1, HEREON.

(SD2) STORM DRAIN OVERFLOW POINT OF CONNECTION.

(SD3) SUMP PUMP PER OTHERS. SHOWN SCHEMATICALLY HEREON.

(SD4) INSTALL CURB DRAIN APWA STD. PLAN 151-4.

(SD5) PVC STORM DRAIN CONVEYANCE PIPING.

(SD6) PVC OVERFLOW PIPE.

SD7) STORM DRAIN POINT OF CONNECTION. SEE PLUMBING PLANS

FOR CONTINUATION FROM ROOF DRAINS.

(SD8) 6" AREA DRAIN BY NDS PRO OR APPROVED EQUAL.

1. ALL DOWNSPOUTS TO DRAIN TO PROPOSED BMPS. SEE PLUMBING PLANS.

2. INSTALL STENCIL EPR DETIAL AT ALL APPLICABLE LOCATIONS

MaxWell®Plus DRAINAGE SYSTEM DETAILS AND SPECIFICATIONS 514 Prospect Ave -16' MIN SEPARATION--16' MIN SEPARATION-Redondo Beach, CA 30" Ø SOLID 1. MANHOLE CONE - MODIFIED FLAT BOTTOM. 2. BOLTED RING & COVER - DIAMETER & TYPE AS SHOWN. CLEAN CAST IRON PRESSURIZED COVER WITH GASKET (NEENAH R-6462-HH). BOLTED. RIM ELEVATION±0.02' OF PLANS. 3. STABILIZED BACKFILL - TWO-SACK SLURRY MIX. 4. PRE-CAST LINER - 4000 PSI CONCRETE 48" ID. X 54" OD. CENTER IN HOLE AND ALIGN SECTIONS TO MAXIMIZE BEARING SURFACE. 5. INLET PIPE/OUTLET PIPE (BY OTHERS). SEE SEPARATE PLAN FOR INVERT ELEVATIONS. 6. GRADED BASIN OR PAVING (BY OTHERS). 7. COMPACTED BASE MATERIAL, IF REQUIRED (BY OTHERS). 8. FREEBOARD DEPTH VARIES WITH INLET PIPE ELEVATION. INCREASE PRIMARY AND SECONDARY CHAMBER DEPTHS AS NEEDED TO MAINTAIN ALL INLET PIPE ELEVATIONS ABOVE RISER PIPE. 9. NON-WOVEN GEOTEXTILE SLEEVE - MIRAFI 140 NL. MIN. 6 FT Ø. HELD APPROX. 10 FEET OFF THE BOTTOM OF EXCAVATION. 10. PUREFLO® DEBRIS SHIELD - ROLLED 16 GA. STEEL X 24" LENGTH WITH VENTED ANTI-SIPHON AND INTERNAL 0.265" MAX. SWO FLATTENED EXPANDED STEEL SCREEN X 12" LENGTH. FUSION BONDED EPOXY COATED. 11. MIN. 6' Ø DRILLED SHAFT. 12. RISER PIPE - SCH. 40 PVC MATED TO DRAINAGE PIPE AT BASE SEAL. 13. DRAINAGE PIPE - ADS HIGHWAY GRADE OR SCH. 40 PVC WITH TRI-A COUPLER. SUSPEND PIPE 15. FLOFAST® DRAINAGE SCREEN - SCH. 40 PVC 0.120" SLOTTED WELL SCREEN WITH 32 SLOTS PER ROW/FT. OVERALL LENGTH VARIES, UP TO 120" WITH TRI-B COUPLER. 16. ABSORBENT - HYDROPHOBIC PETROCHEMICAL SPONGE. MIN. 128 OZ. CAPACITY. TYPICAL, 2 PER 6" Ø 13 17. FABRIC SEAL - U.V. RESISTANT GEOTEXTILE - TO BE REMOVED BY CUSTOMER AT PROJECT 18. MIN. 4' Ø DRILLED SHAFT. 19. BASE SEAL - CONCRETE SLURRY. 20. 6 PERFORATIONS MINIMUM PER FOOT, 2 ROWS MINIMUM. 22. INTAKE SCREEN - 4" Ø SCH. 40 PVC 0.120" MODIFIED SLOTTED WELL SCREEN WITH 32 SLOTS PER ROW/ FT. 48" OVERALL LENGTH WITH TRI-C END CAP. 23. VENTED ANTI-SIPHON INTAKE WITH FLOW REGULATOR. 24. CONNECTOR PIPE - 4" Ø SCH. 40 PVC. Manufactured and Installed by **TORRENT** R E S O U R C E S
An evolution of McGuckin Drilling www.torrentresources.com AIL: DPD-4-SS-CA REVISED BY: AB USE W5 WWF AT 5" ON CENTER

Maxwell® Plus Drainage System Calculations Prepared on January 27, 2022 Project: Beach City Health District - Redondo Beach, CA Contact: Connor Crowley at Labib Funk + Associates - Los Angeles, CA

TORRENT

Design Infiltration Rate Mitigated Volume <u>8,696</u> ft³ Required Drawdown Time <u>96</u> hours Min. Depth to Infiltration <u>10</u> ft Groundwater Depth for Design

RAWN ON: 05-17-19 REVISED DATE: 01-27-22 SCALE: N.T.S

1 MAXWELL IV DRYWELL

Drywell Rock Shaft Diameter Primary Chamber Depth <u>19</u> ft <u>19</u> ft Drywell Chamber Depth Rock Porosity Depth to Infiltration Drywell Bottom Depth

Convert Design Rate from in/hr to ft/sec. 4.18 $\frac{\ln r}{hr} \times \frac{1 \text{ ft}}{12 \ln r} \times \frac{1 \text{ hr}}{3600 \text{ sec}} = 0.000097 \frac{\text{ft}}{\text{sec}}$

A 4 foot diameter drywell provides 12.57 SF of infiltration area per foot of depth, plus 12.57 SF at the bottom.

For a 50 foot deep drywell, infiltration occurs between 15 feet and 50 feet below grade. This provides 35 feet of infiltration depth in addition to the bottom area. Infiltration area per drywell is calculated below. 6 ft x 18.85 $\frac{ft^2}{ft}$ + 29 ft x 12.57 $\frac{ft^2}{ft}$ + 12.57 ft t^2 = 490 ft t^2

Combine design rate with infiltration area to get flow (disposal) rate for each drywell. $0.000097 \frac{ft}{sec} \times 490 ft^2 = 0.04742 \frac{ft^3}{sec}$

Volume of disposal for each drywell based on various time frames are included below. 96 hrs: 0.0474 CFS x 96 hours x $\frac{3600 \, \text{sec}}{1 \, \text{hr}}$ = 16,389 cubic feet of retained water disposed of. Chamber diameter = 4 feet. Drywell rock shaft diameter = 4 feet.

Volume provided in each primary settling chamber with depth of 19 feet. 19 ft \times 12.57 ft² = 239 ft³ Volume provided in each drywell with chamber depth of 19 feet. 19 ft x 12.57 ft² + 2 ftx 28.27 ft² x 40 % + 29 ftx 12.57 ft² x 40 % = 407 ft³

The MaxWell System is composed of 3 drywell(s) and 1 primary chamber(s).

Total volume provided = 1460 ft^3 Total 96 hour infiltration volume = 49,166 ft³ Total infiltration flowrate = $0.14226 \frac{ft^3}{sec}$

Based on the total mitigated volume of 8696 CF, after subtracting the volume infiltrated as quickly as it enters the drywell of 7358 CF, the remaining volume is 1338 CF. The storage provided in the drywell system is 1460 CF.

For any questions, please contact Alex Bennett at 213-248-4167 or via email at Alex.Bennett@Oldcastle.com

> Torrent Resources (CA) Incorporated 9950 Alder Avenue Bloomington, CA 92316 Phone 909-829-0740

HydroCalc Volume Analysis

Total Time of Storm Event (MIN)*

Total Volume Infiltrated as it Enters Drywell (CF)

VOLUME INFILTRATED FROM MIN

0 TO 1033.2 = 4650.6 CF.

Total Storage within MaxWell System (CF)

Remaining Detention Required (CF)

Project: Beach City Health District - Subarea Site * (Values from project "Peak Flow Hydrologic Analysis")

CALIFORNIA 909-829-0740

1490

7358

1460

N/A

TOTAL VOLUME =

HydroCalc Output Results* Clear Peak Flow (CFS) 0.4883 24-Hr Clear Runoff Volume (AC-FT) 0.1996 24-Hr Clear Runoff Volume (CF) Analysis 0.14226 Drywell Disposal Rate (CFS) Total Volume Infiltrated During 1st Phase (CF) 4650.6 1033.2 [2nd Phase] Storm Flow Rate Exceeds Drywell Disposal Rate @ (MIN) 1568.8 Total Volume Infiltrated During 2nd Phase (CF) [3rd Phase] Drywell Disposal Rate Exceeds Storm Flow Rate @ (MIN) 1217 Total Volume Infiltrated During 3rd Phase (CF) 1139


Hydrograph: Beach City Health District - Site Volume Infiltrated by Drywell (cf) —Clear Peak Flow (cfs) —Drywell Disposal Rate (cfs) **VOLUME INFILTRATED AS IT ENTERS = 4650.6 + 1568.8 + 1139** = 7358.4 CF (7358 CF). VOLUME INFILTRATED FROM MIN 1033.2 TO 1217 = (1217-1033.2) MIN X 60 SEC/MIN X 0.14226 CFS = 1568.8 AT TIME 1217 MIN, TOTAL VOLUME = AT TIME 1033.2 MIN, 7556.8 CF. TOTAL VOLUME = 4650.6 VOLUME INFILTRATED FROM MIN 1217 TO 1490 = 8695.8 -7556.8 = 1139 CF. 0 50 100 150 200 250 300 350 400 450 500 650 600 650 700 750 800 850 900 950 1000 1050 1100 1150 1200 1250 1300 1350 1400 1450 AT TIME 1490 MIN,
Time (minutes)



PAUL MURDOCH ARCHITECTS


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El Segundo, CA 90245 Tel: 213.239.9700 JLA Job No. 19725

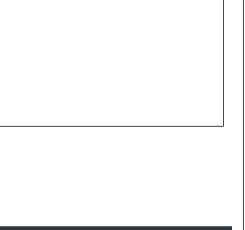

NO. DATE **BEACH CITIES HEALTH DISTRICT**

HEALTHY LIVING

CAMPUS

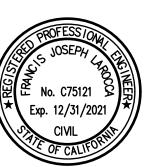514 NORTH PROSPECT AVE. REDONDO BEACH, CA 90277

PMA PROJECT NO.


DRAWING TITLE LOW IMPACT DEVELOPMENT/ DRAINAGE PLAN

AS NOTED DATE 01/06/20

Author Checker SHEET NO.


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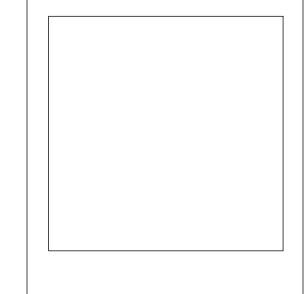
CHECKED



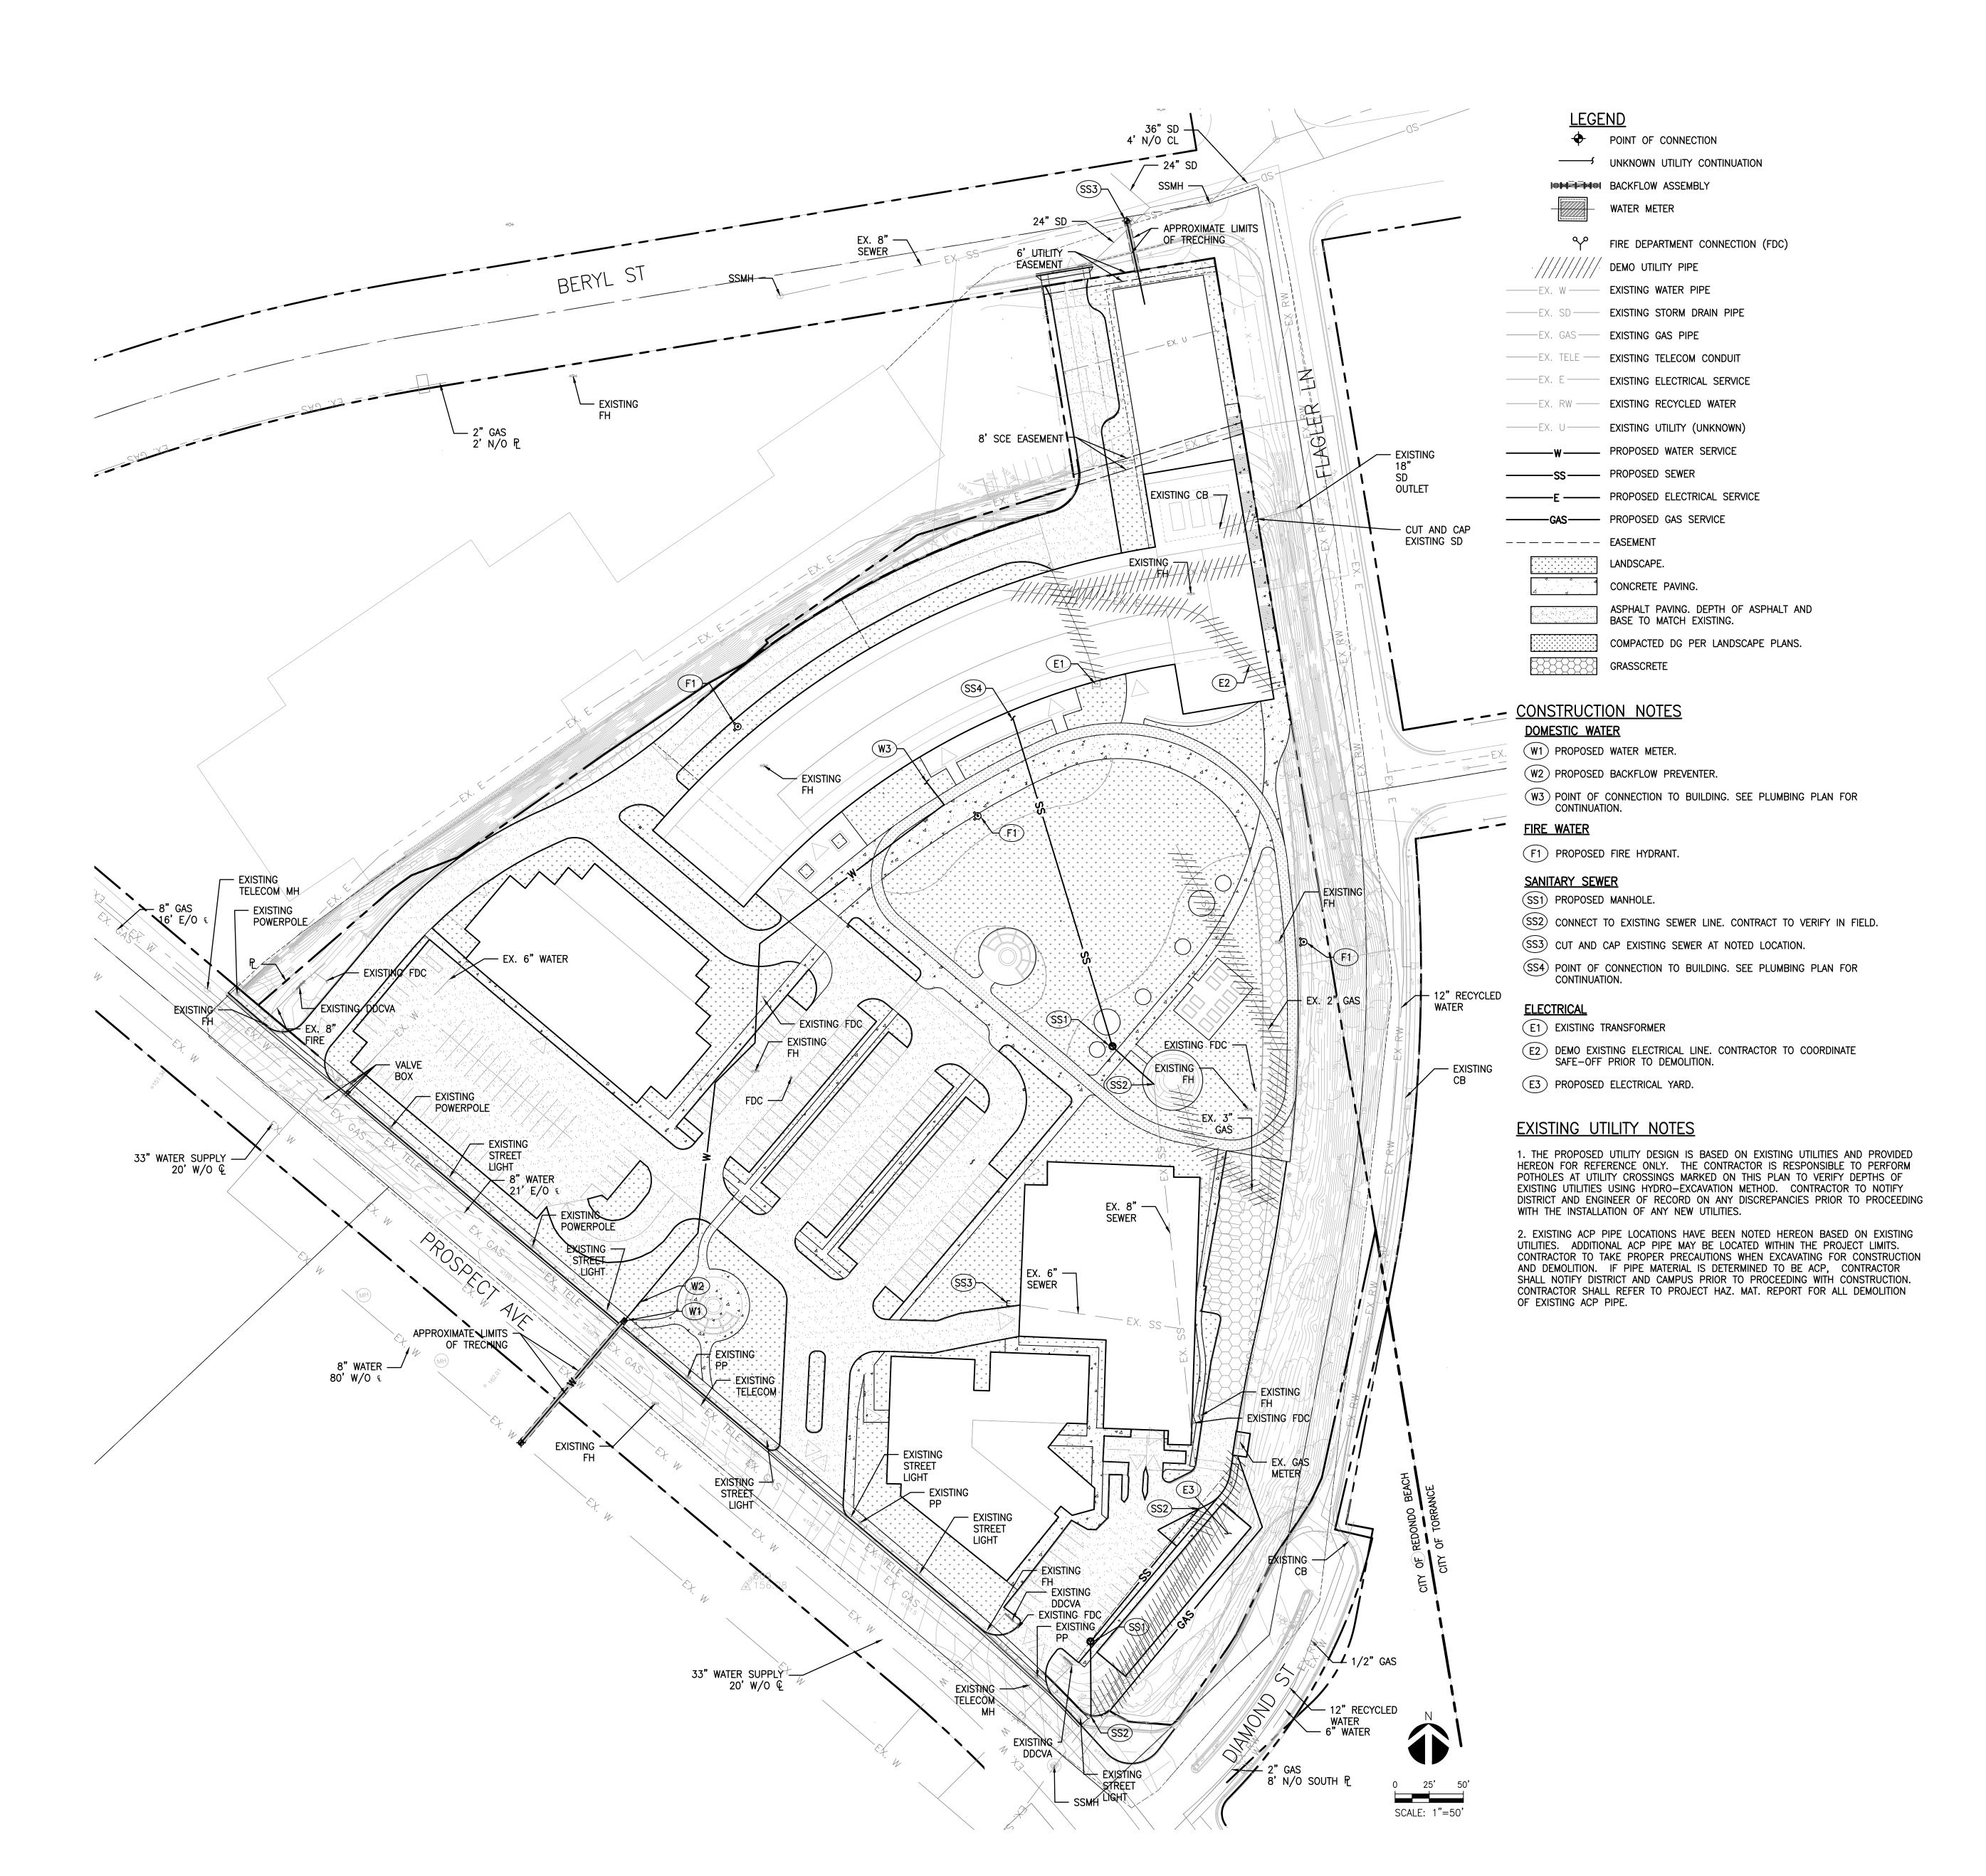

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Tel: 213.239.9700 JLA Job No. 19725



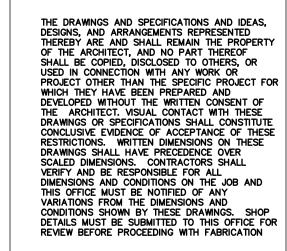

DATE

BEACH CITIES HEALTH DISTRICT HEALTHY LIVING CAMPUS

514 NORTH PROSPECT AVE. REDONDO BEACH, CA 90277

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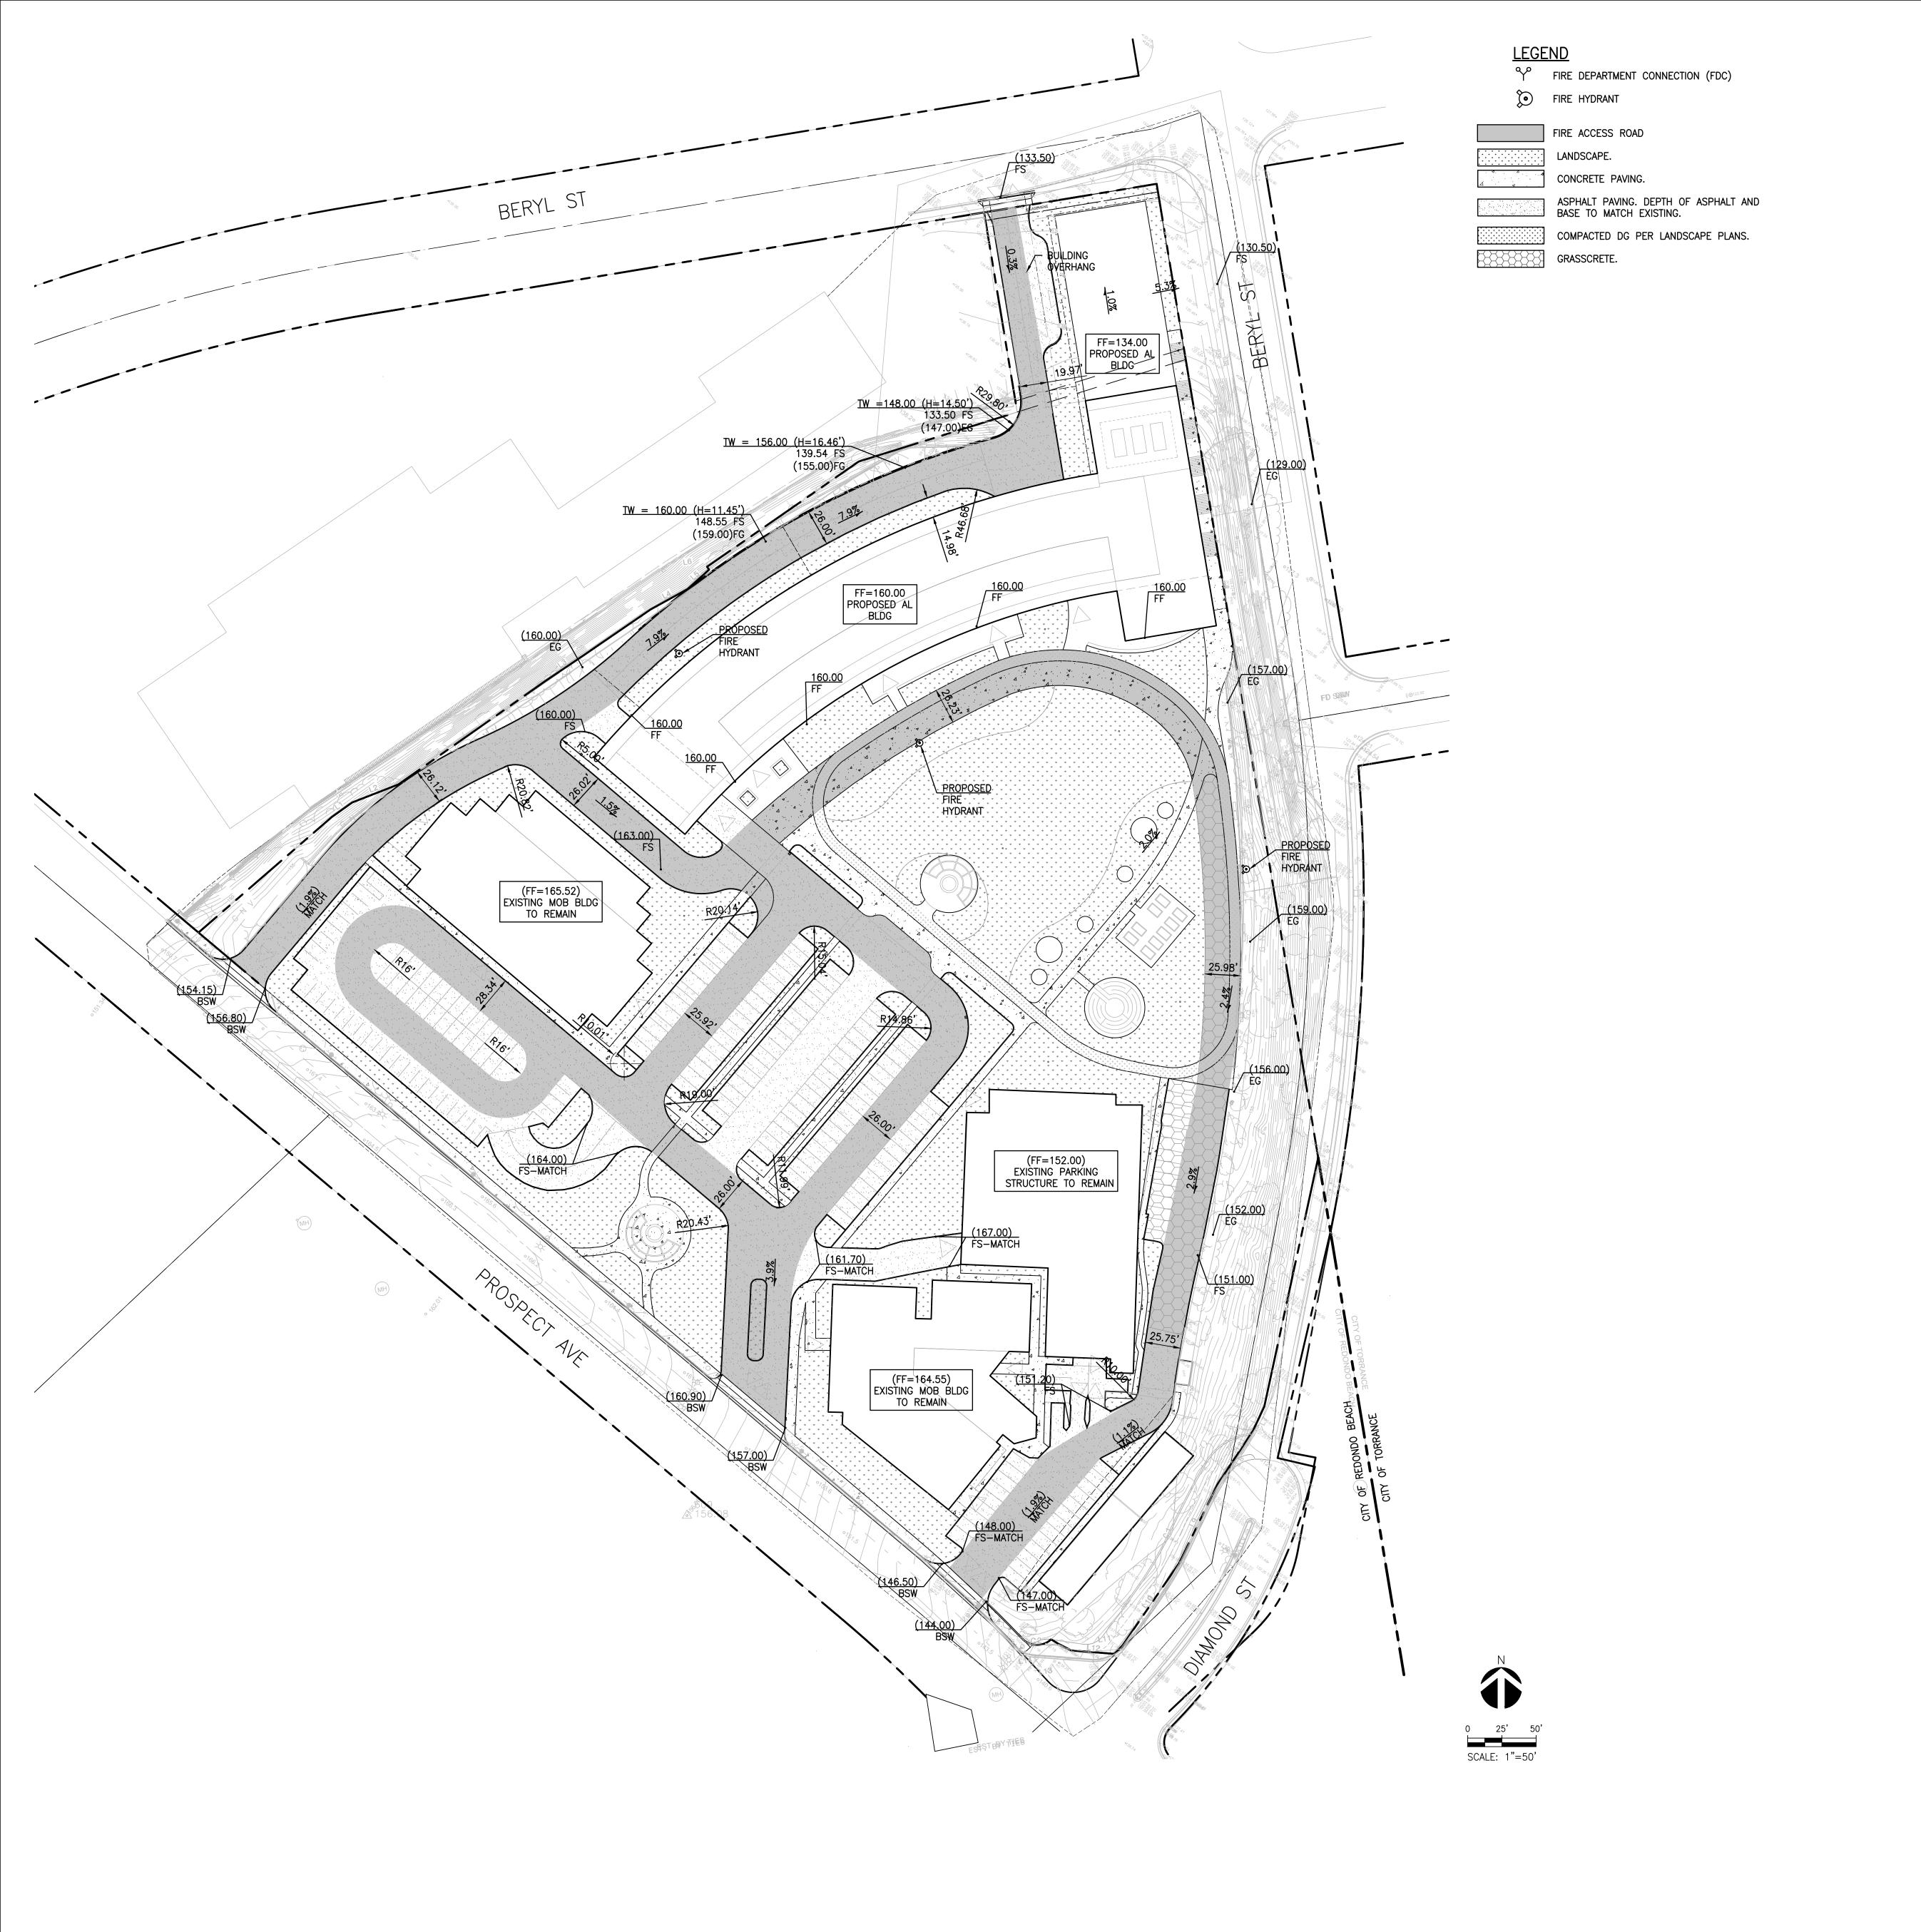
DRAWING TITLE

UTILITY PLAN

AS NOTED

01/06/20 CHECKED Author Checker


C400





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514 NORTH PROSPECT AVE. REDONDO BEACH, CA 90277

PMA PROJECT NO.

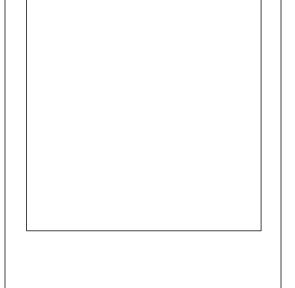DRAWING TITLE

FIRE ACCESS PLAN

SCALE
AS NOTED

DATE 01/06/20 DRAWN
Author Checker

HEALTH DISTRICT HEALTHY LIVING CAMPUS

514 NORTH PROSPECT AVE. REDONDO BEACH, CA 90277

PMA PROJECT NO.

DRAWING TITLE


NEW 4160VA MEDIUM VOLTAGE SERVICE FROM SCE SINGLE LINE DIAGRAM

As indicated


01/29/2022

L. K./D. S. SHEET NO.

E200 L.A.I.# 22-503 PAPER SIZE 42"x30"

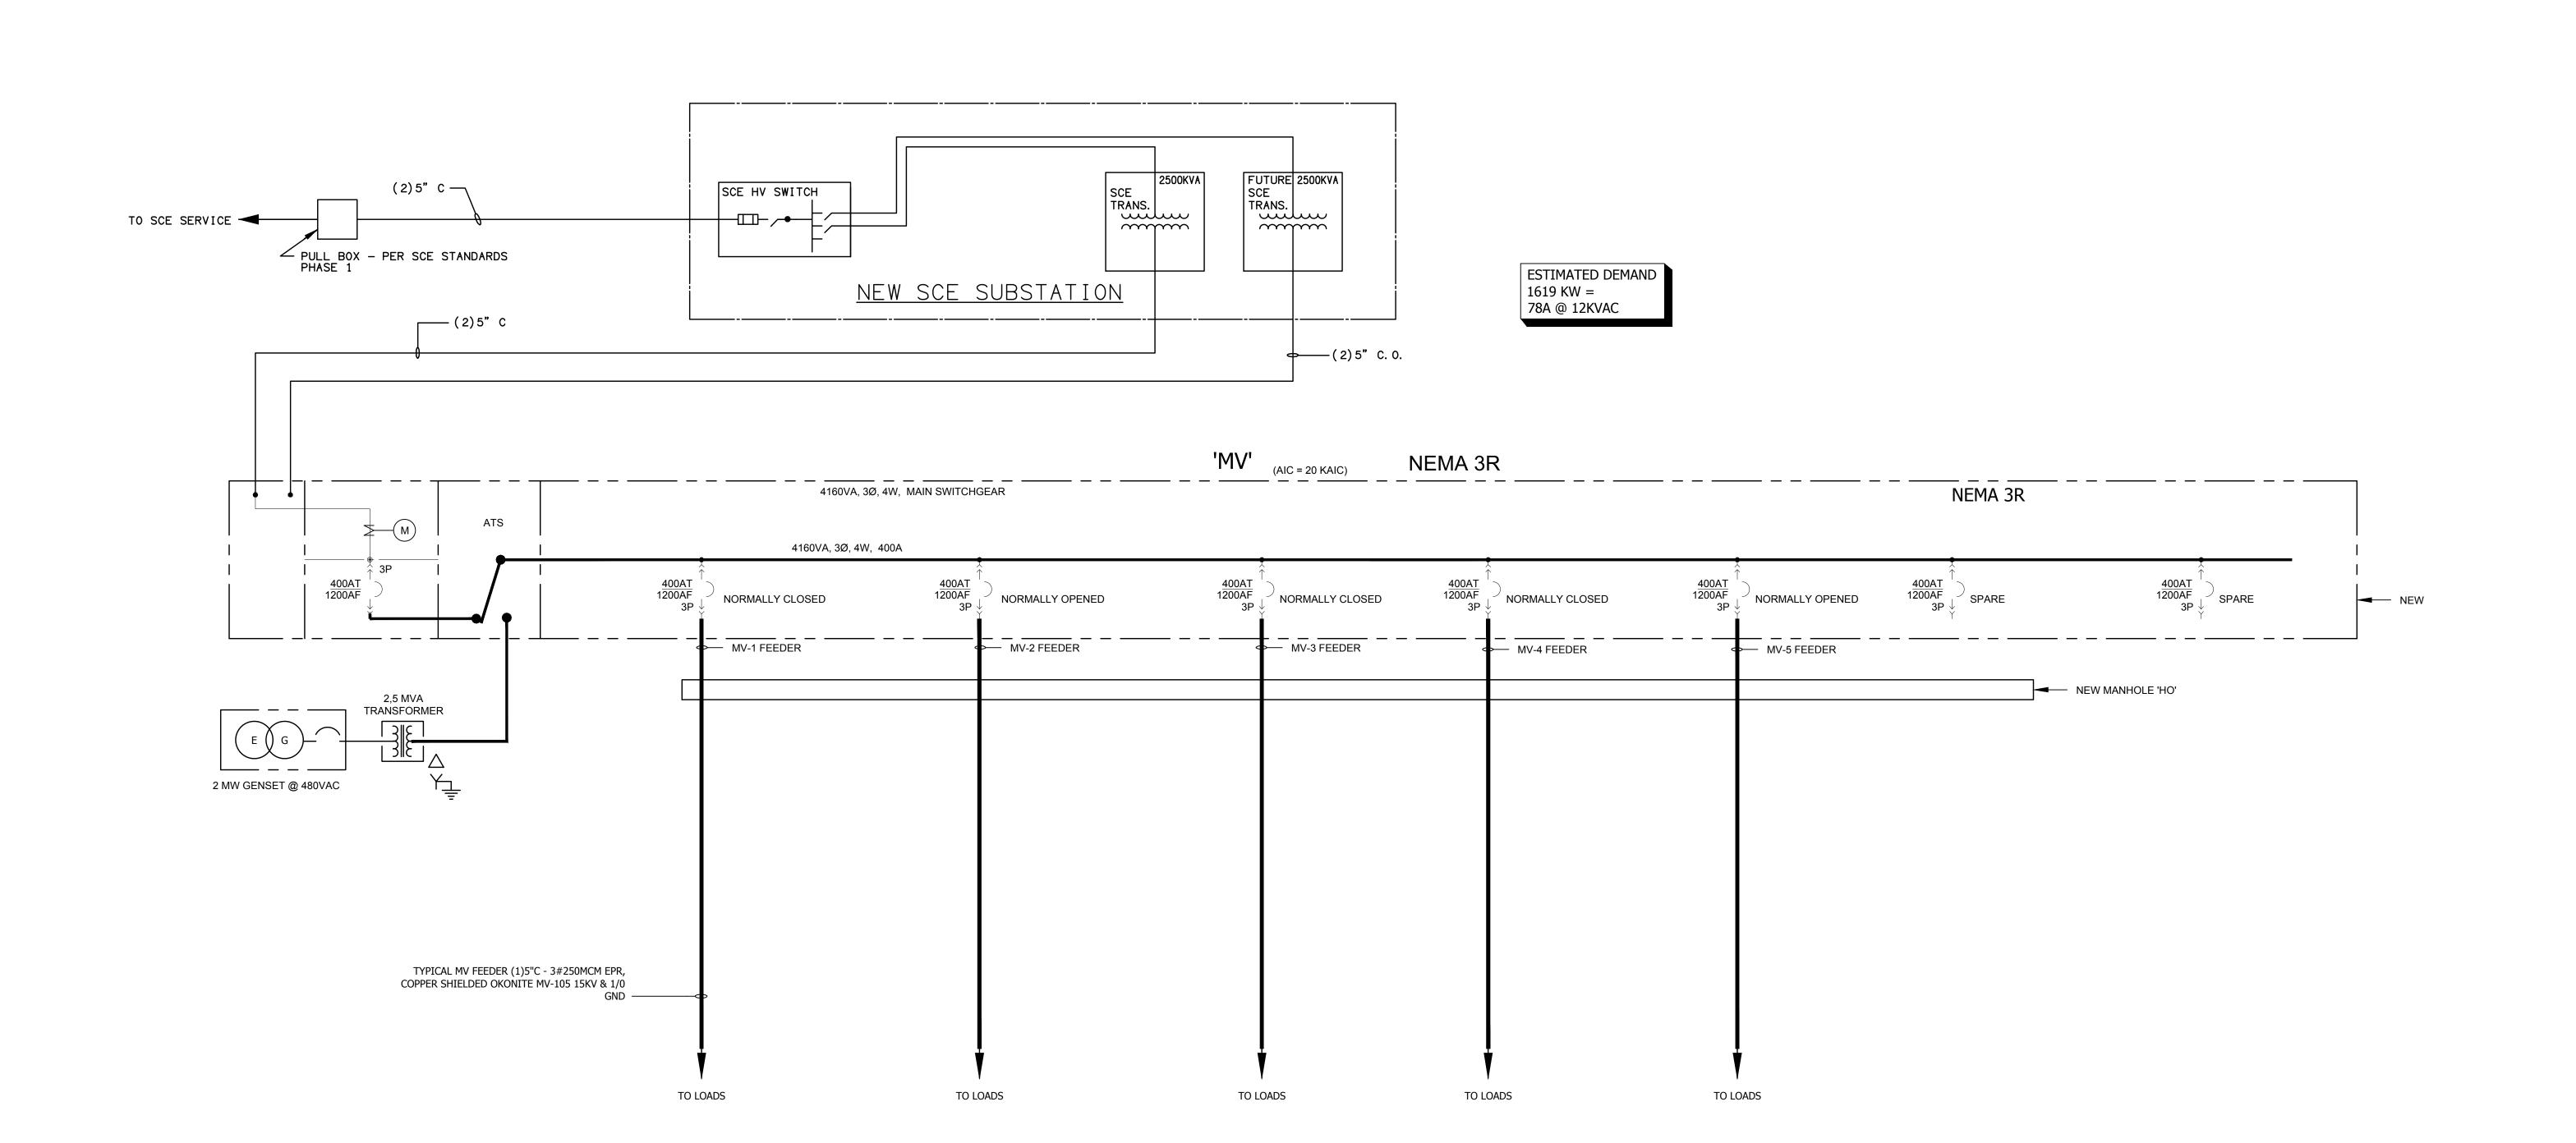

NEW 4160VA MEDIUM VOLTAGE SERVICE FROM SCE SINGLE LINE DIAGRAM

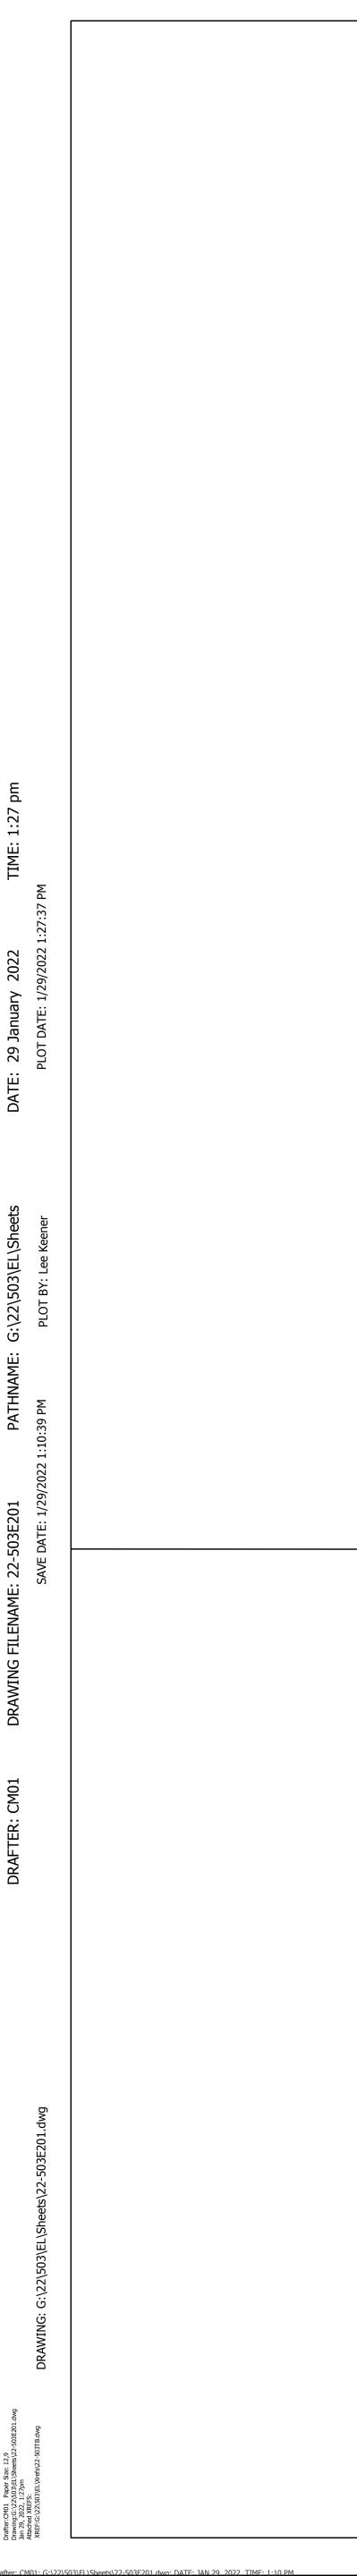

120/240 VAC CONTROL POWER

UTILITY METERS

 $\Diamond \bigcirc -$

SCE METERING SECTION

METAL CLAD 'HVMSB' 15KV SWITCHGEAR SINGLE LINE

2.5MVA
TRANSFORMER
480-12KV

TYP FEEDER C/B TWO HIGH SECTION

2 MW GENERATOR

SCALE: NONE


50/51,50/51G

MAIN C/B SECTION


TYPICAL FEEDER C/B SECTION:

3-C/T'S 1-CM OR PM MONITOR 1-3¢ SECTION 220 RELAY W/ 50/51 & 50/51G

SČE U/G P/S

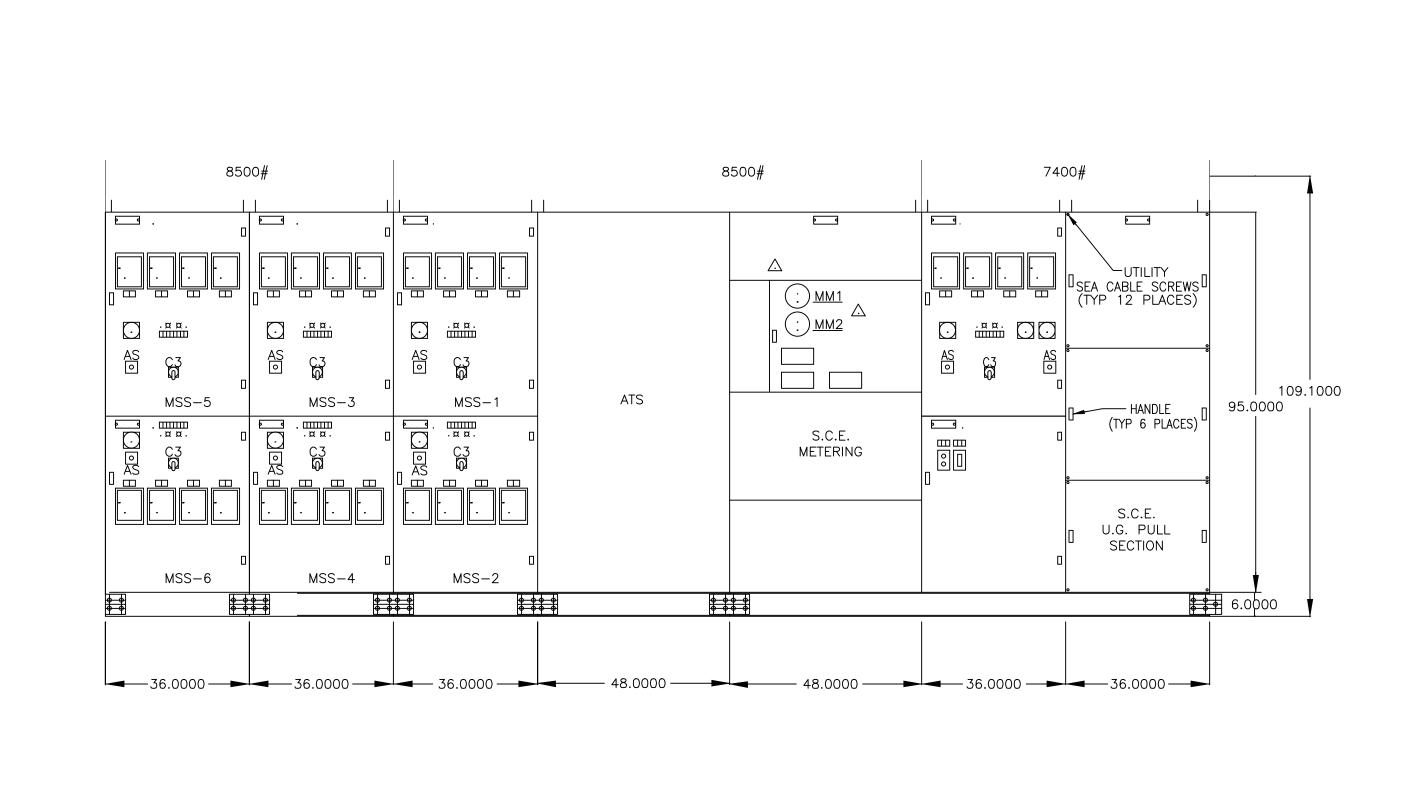

2 - E201 -METAL CLAD 15KV SWITCHGEAR FRONT ELEVATION SCALE: NONE NEMA 3R

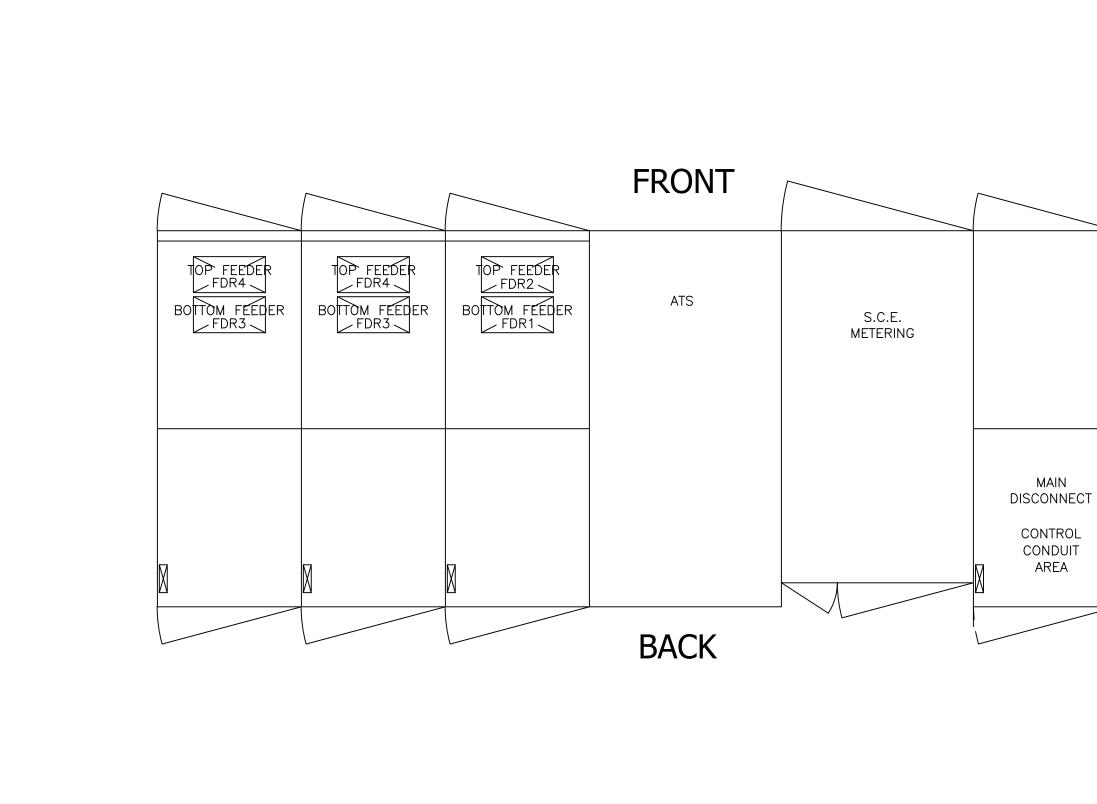

15KV SWITCHGEAR PLAN VIEW SCALE: NONE

S.C.E. U.G. PULL SECTION

ARCHITECTS

PAUL MURDOCH

6310 SAN VICENTE BLVD SUITE 400 LOS ANGELES, CALIFORNIA 90048 310 358-0993

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LUBBI E INBUEELL E INBULL CONSULTING ELECTRICAL ENGINEERS 3251 CORTE MALPASO, #511 CAMARILLO, CA 93012-8094 (805) 389-6520 FAX (805) 389-6519 LUCCI & ASSOCIATES, INC. reserve their commonlaw copyright and other property rights in these plans. These plans and drawings

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> BEACH CITIES **HEALTH DISTRICT HEALTHY LIVING** CAMPUS

514 NORTH PROSPECT AVE. REDONDO BEACH, CA 90277

PMA PROJECT NO.

DRAWING TITLE METAL CLAD 5KV

SWITCHGEAR **ELEVATIONS**

As indicated 01/29/2022

L. K./D. S. SHEET NO.

E201

L.A.I.# 22-503 PAPER SIZE 42"x30"

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